

INFORMATION SHOWN FOR REFERENCE PURPOSES ONLY. SITE PLAN FROM GOOGLE MAP 2016



## SITE AERIAL VIEW



INFORMATION SHOWN FOR REFERENCE PURPOSES ONLY. SITE PLAN FROM GOOGLE MAP 2016

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### PROJECT TEAM

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### CIVIL ENGINEER/ SURVEYOR

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### LEGAL DESCRIPTION

### ALTA COMMITMENT 0039325-06

LOTS I AND 7, AND PARCEL C, KELKARI, A BINDING SITE PLAN, ACCORDING TO THE PLAT THEREOF, RECORDED IN VOLUME 191 OF PLATS, PAGES 16 THROUGH 21, IN KING COUNTY, WASHINGTON; AND LOT 2, CITY OF ISSAQUAH BOUNDARY LINE ADJUSTMENT NUMBER PLN 01-00044, RECORDED UNDER RECORDING NUMBER 20010807900008, BEING A PORTION OF LOT 2, KELKARI, A BINDING SITE PLAN, ACCORDING TO THE PLAT THEREOF, RECORDED IN VOLUME 191 OF PLATS, PAGES 16 THROUGH 21, IN KING COUNTY, WASHINGTON.

ALTA COMMITMENT 0039346-06 LOTS 8, 9, AND 10, AND PARCEL B, KELKARI, A BINDING SITE PLAN, ACCORDING TO THE PLAT THEREOF, RECORDED IN VOLUME 191 OF PLATS, PAGES 16 THROUGH 21, IN KING COUNTY, WASHINGTON.

MSPA16-00001





### PROJECT DESCRIPTION

KELKARI IS A RESIDENTIAL COMMUNITY LOCATED IN THE SUNRISE NEIGHBORHOOD OF SOUTH ISSAQUAH, NEAR THE INTERSECTION OF SUNRISE PLACE SOUTHWEST AND CABIN CREEK LANE SOUTHWEST. THE MASTER SITE PLAN, SITE DEVELOPMENT PERMIT, AND BINDING SITE PLAN FOR KELKARI WERE APPROVED IN 1998. THE DEVELOPMENT WAS APPROVED TO BE COMPRISED OF 189 DWELLING UNITS IN 9 BUILDINGS, EACH WITH A PROPOSED HEIGHT OF APPROXIMATELY 50 FEET. PHASE-I, WITH 63 DWELLING UNITS AND THE CLUBHOUSE, WAS COMPLETED IN 1999. THIS APPLICATION CONCERNS THE PHASE-2 AND PHASE-3 PROJECT AREAS. PHASE-2 AND 3 WILL INCLUDE A TOTAL OF 75 TOWNHOUSE STYLE BUILDINGS, WITH A MAXIMUM HEIGHT NOT TO EXCEED 45 FEET. THE PHASE-2 PROJECT AREA IS LOCATED ON THE NORTH SIDE OF SUNRISE PLACE SOUTHWEST, AND PHASE-3 IS ON THE SOUTH SIDE. THE PHASE-2 PROJECT AREA HAS BEEN CLEARED, GRADED, AND LANDSCAPED, AND SITE IMPROVEMENTS (I.E., THE MAIN ACCESS ROAD AND STORMWATER MANAGEMENT SYSTEM/VAULT) HAVE BEEN CONSTRUCTED AS PART OF PHASE-I, AND INCLUDE ACCOMMODATION OF THE FUTURE PHASE-2. THE PHASE-3 PROJECT AREA IS UNDEVELOPED BEYOND THE EXISTING ACCESS INTERSECTION. GRADING TO ESTABLISH LOT AND ROADWAY ELEVATIONS WILL BE MODERATE, WITH CUTS AND FILLS OF 2.0-20.0 FEET PLANNED THROUGHOUT THE SITE AS SOME IMPACTS TO WETLANDS ARE ANTICIPATED, A WETLAND MITIGATION AREA IN PHASE-3 IS ALSO INCLUDED AS PART OF THE PROJECT.

### PROJECT DATA

GROSS FLOOR AREA (GFA):

REQUIRED PARKING:

PROJECT NAME:	KELKARI TOWNHOMES
PROJECT ADDRESS:	1000 CABIN CREEK LN S.W.
PROJECT JURISDICTION:	CITY OF ISSAQUAH, WASHINGTON
TAX PARCEL #'S:	380090-0010, 0020, 0070, 0900, 0130, 0080, 0090, 0100, 0120
LAND USE ZONE:	MF-M (MUTI-FAMILY MEDIUM DENSITY)
CONSTRUCTION TYPE:	PER IBC 2012 & WA STATE AMENDMENTS, TYPE V-B, SPRINKLERED, NFPA RI3
TYPE OF OCCUPANCY:	R-2
FLOOR AREA RATIO (FAR):	NA
MAX BUILDING HEIGHT:	PER ISSAQUAH MUNICIPAL CODE- SECTIONS 18.07.0 AND 18.07.360 TABLE (1): MAX. BUILDING HEIGHT ALLOWED = 50'-0" MAX. BUILDING HEIGHT PROPOSED = 45'-0"

SEE TABLE THIS SHEET

IMPERVIOUS SURFACES AND PERVIOUS SURFACES:

REFER TO CIVIL FOR OPEN SPACE (IMPERVIOUS SURFACES AND PERVIOUS SURFACES) AND CALCULATIONS.

PER SECTION/ TABLE 18.09.050: 2/ UNIT

UNIT TYPE	PHASE 2	PHASE 3	TOTAL
А	26	0	26
В	9	19	28
C	0	12	12
C *	0	9	9
TOTAL	35	40	75

PARKING

PARKING STALL SIZE: 9'-0" x 18'-6" EACH BICYCLE RACK FOR 3+ BICYCLES

### GROSS FLOOR AREA (GFA)

UNIT TYPE	PHASE 2 (SF)	PHASE 3 (SF)	TOTAL (SF)
А	54,444	0	54,444
В	21,834	46,094	67,928
C	0	23,244	23,244
C *	0	21,960	21,960
TOTAL	76,278	91,298	167,576

### \* UNIT 'C' TYPE W/ MASTER BEDROOM AT ROOF LEVEL @ DEVELOPER'S OPTION

### SHEET INDEX

AOI <u>CIVIL</u>	COVER SHEET
PI P2 P3 P4 P5 P6	BOUNDARY/TOPOGRAPHIC SURVEY BOUNDARY/TOPOGRAPHIC SURVEY PRELIMINARY GRADING AND UTILITY PLAN PRELIMINARY GRADING AND UTILITY PLAN FIRE DEPARTMENT SITE PLAN FIRE DEPARTMENT SITE PLAN SITE DISTURBANCE EXHIBIT DI

### <u>ENVIROMENTAL</u>

MI	EXISTING CONDITIONS
M2	IMPACTS AND MITIGATION AREAS
M3	TESC PLAN
M4	MITIGATION PLAN
M5	GRADING PLAN
M6	PLANTING PLAN
M7	DETAILS AND PLANT INSTALL NOTES (I OF 2)
M8	DETAILS AND PLANT UNSTALL NOTES (2 OF 2)

### <u>LANDSCAPE</u>

L100	NORTH SITE LANDSCAPE PLAN
LIOI	SOUTH SITE LANDSCAPE PLAN
L102	ENLARGED VIEW - AMENITY SPACES
L103	ENLARGED VIEW - AMENITY SPACES
L104	PLANTING SCHEDULE
L200	LANDSCAPE LIGHTING
L201	LANDSCAPE LIGHTING
L202	BUILDING ENTRY ENLARGEMENT
L300	SITE FURNISHING
L400	LANDSCAPE DETAILS

### ARCHITECTURAL

ROHILCI	URAL
02	SITE PLAN PHASE II & III
KO3	SITE SECTIONS PHASE II & III
04 05	FLOOR PLANS UNIT-A FLOOR PLANS UNIT-B
106 106	EXTERIOR ELEVATIONS UNIT-C
<b>NOT</b>	FLOOR PLANS UNIT-C
108	MAIL KIOSK & ENLARGED PLA
109	MATERIAL BOARD

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## IS PROPERTY INVESTMENTS LLC

PROJECT NUMBER:	15-0357
PROJECT MANAGER:	JG
DRAWN BY:	BD
PLOT DATE:	Feb 15, 2016 - 10:27am

SDP/ MSP/ BSP MINOR **AMENDMENT APPLICATION** 2-12-16


### REVISIONS:

FEBRUARY 12, 2016 SDP/ MSP/ BSP **AMENDMENT** APPLICATION



10801 Main Street, #110 | Bellevue,WA 98004 1904 Third Avenue, #330 | Seattle, WA 98101 BaylisArchitects.com | (425) 454 0566

**COVER SHEET** 

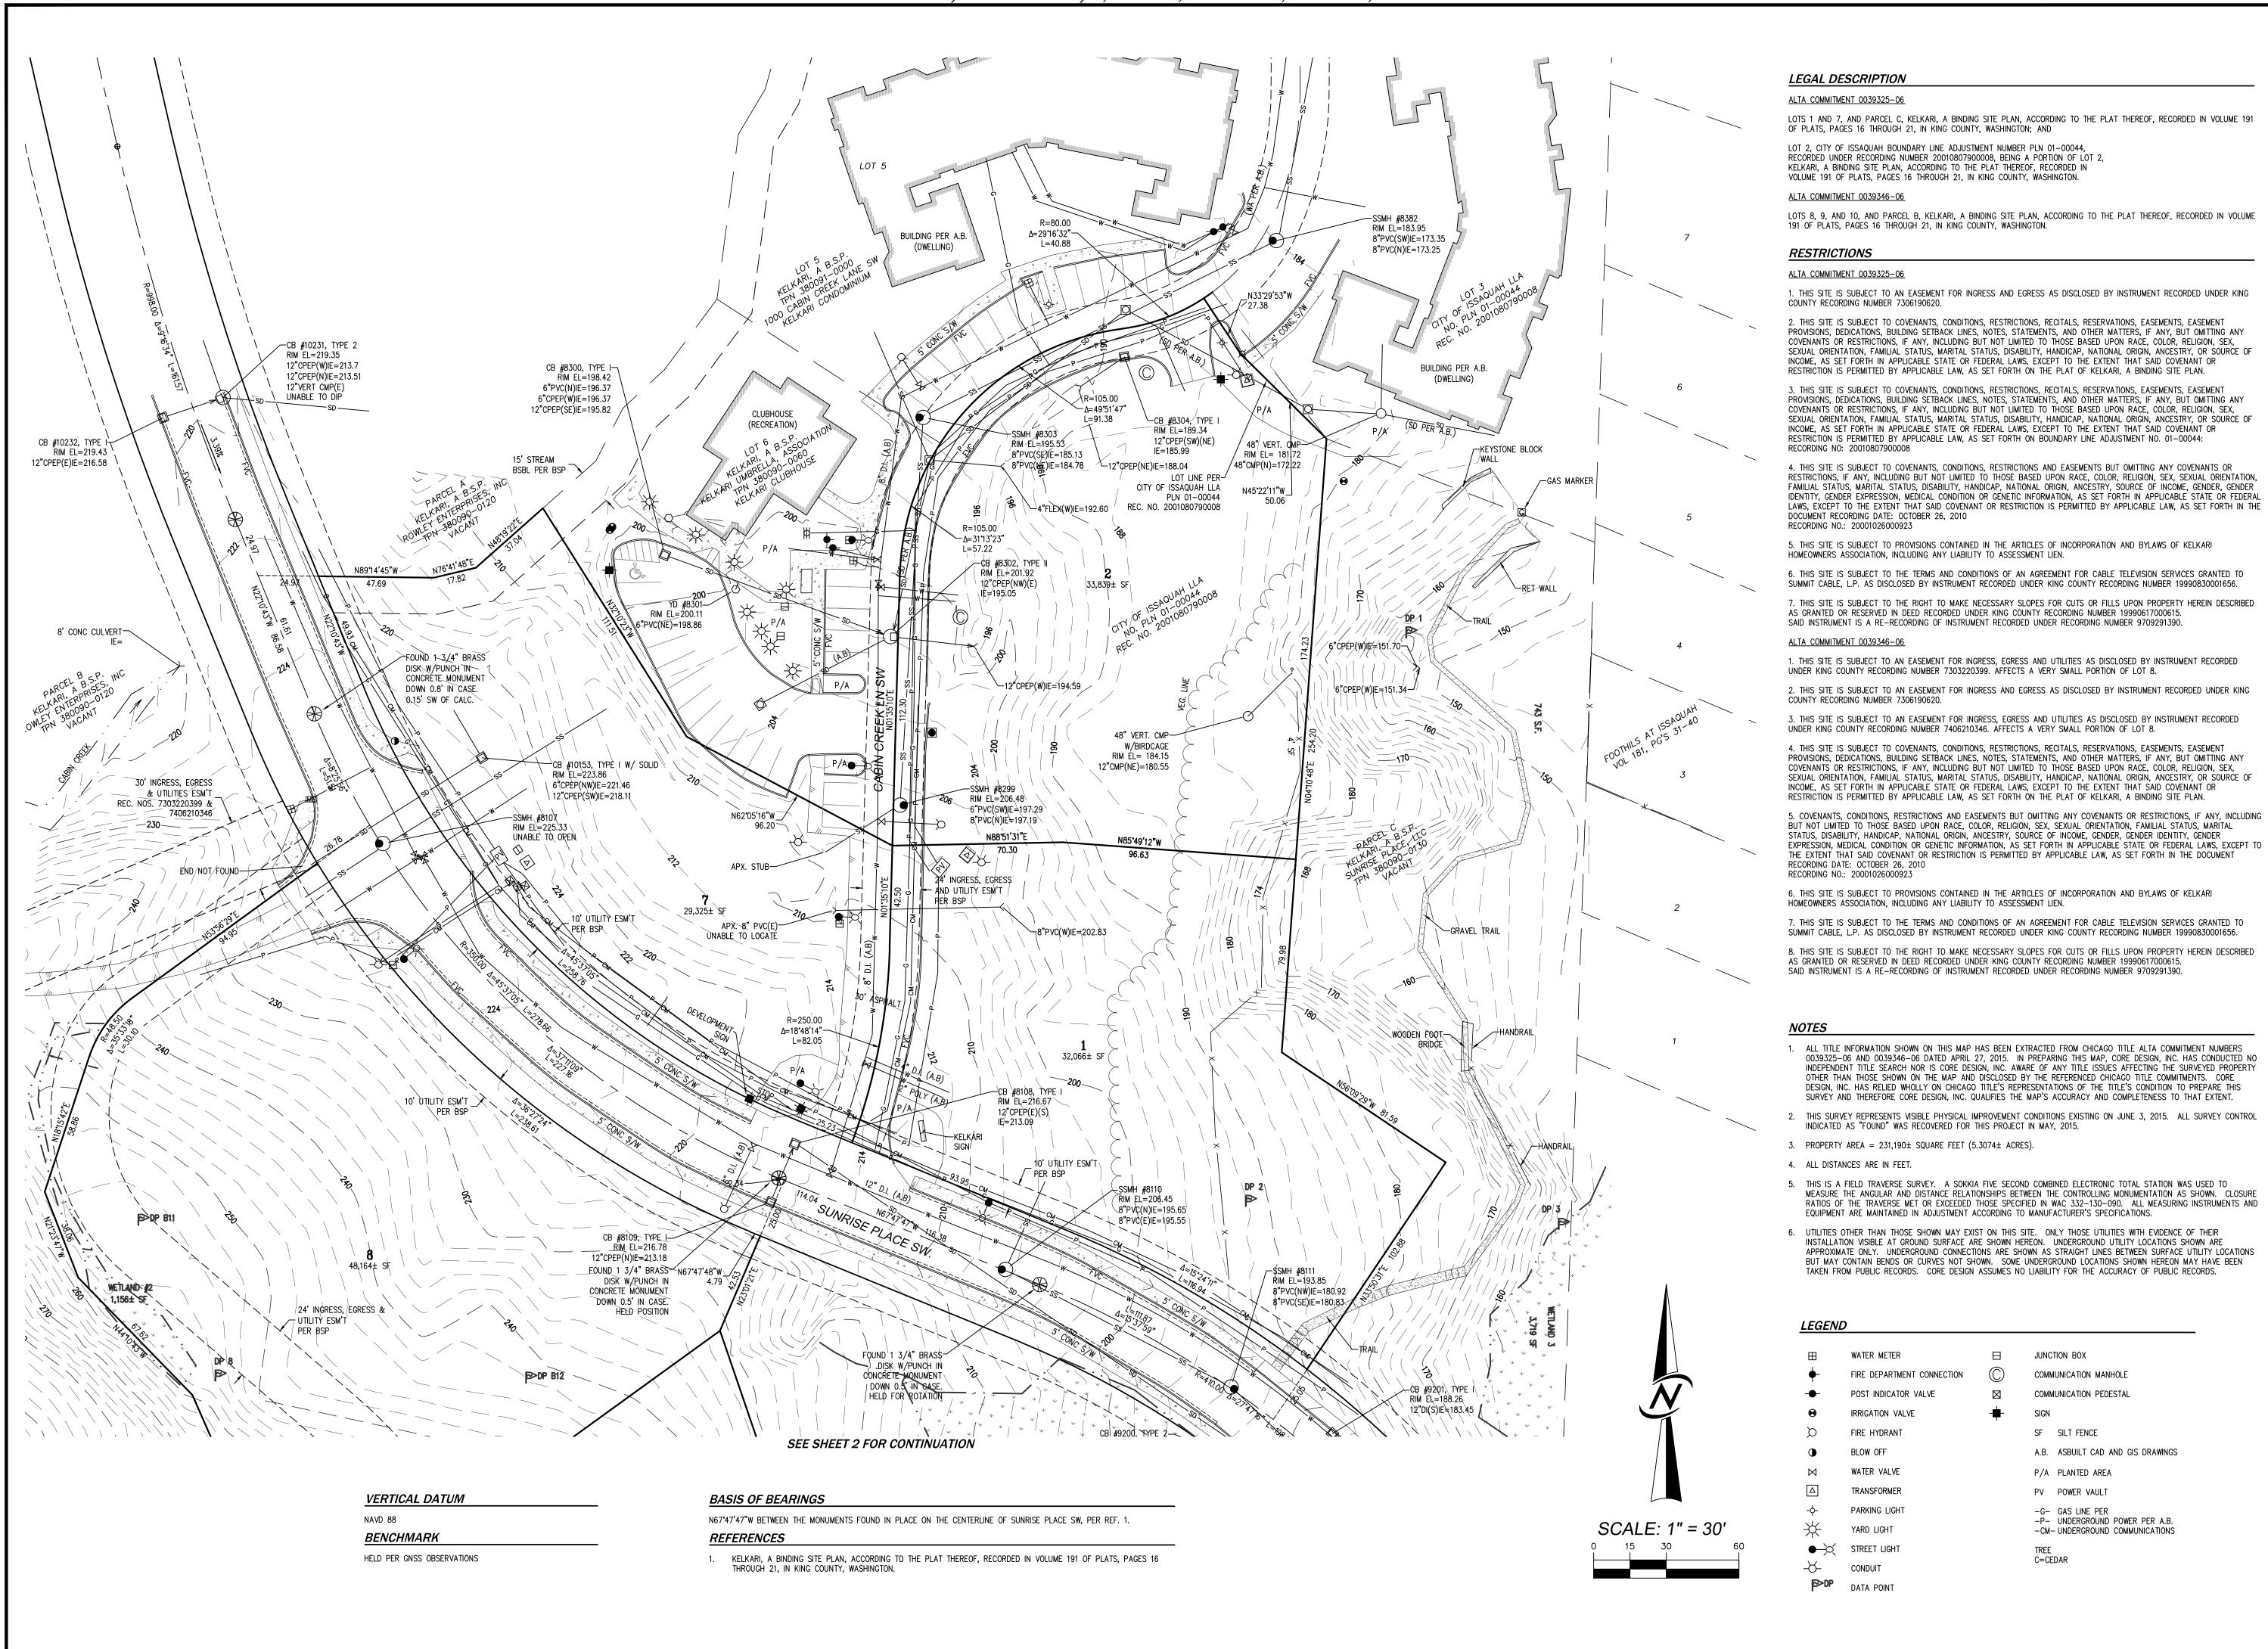

DAVID

WASHINGTON

WASHIN

WASHINGTON

WASHINGTON

WASHINGTON

WASHINGTON

WASHINGTON

WAS

wue, Washington 98007 885.7877 Fax 425.885.7963 N.G. S.IIR.V.F.Y.I.N.G.

DESIGN DESIGN NGINEERING PL

IDARY/TOPOGRAPHIC SURVE

ELKARI TOWNHOMES

OPERTY INVESTMENTS, LL

A19 OCCIDENTAL AVENUE SOUTH, SUITE 300

SEATTLE MA ORIGINAL

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N FDW

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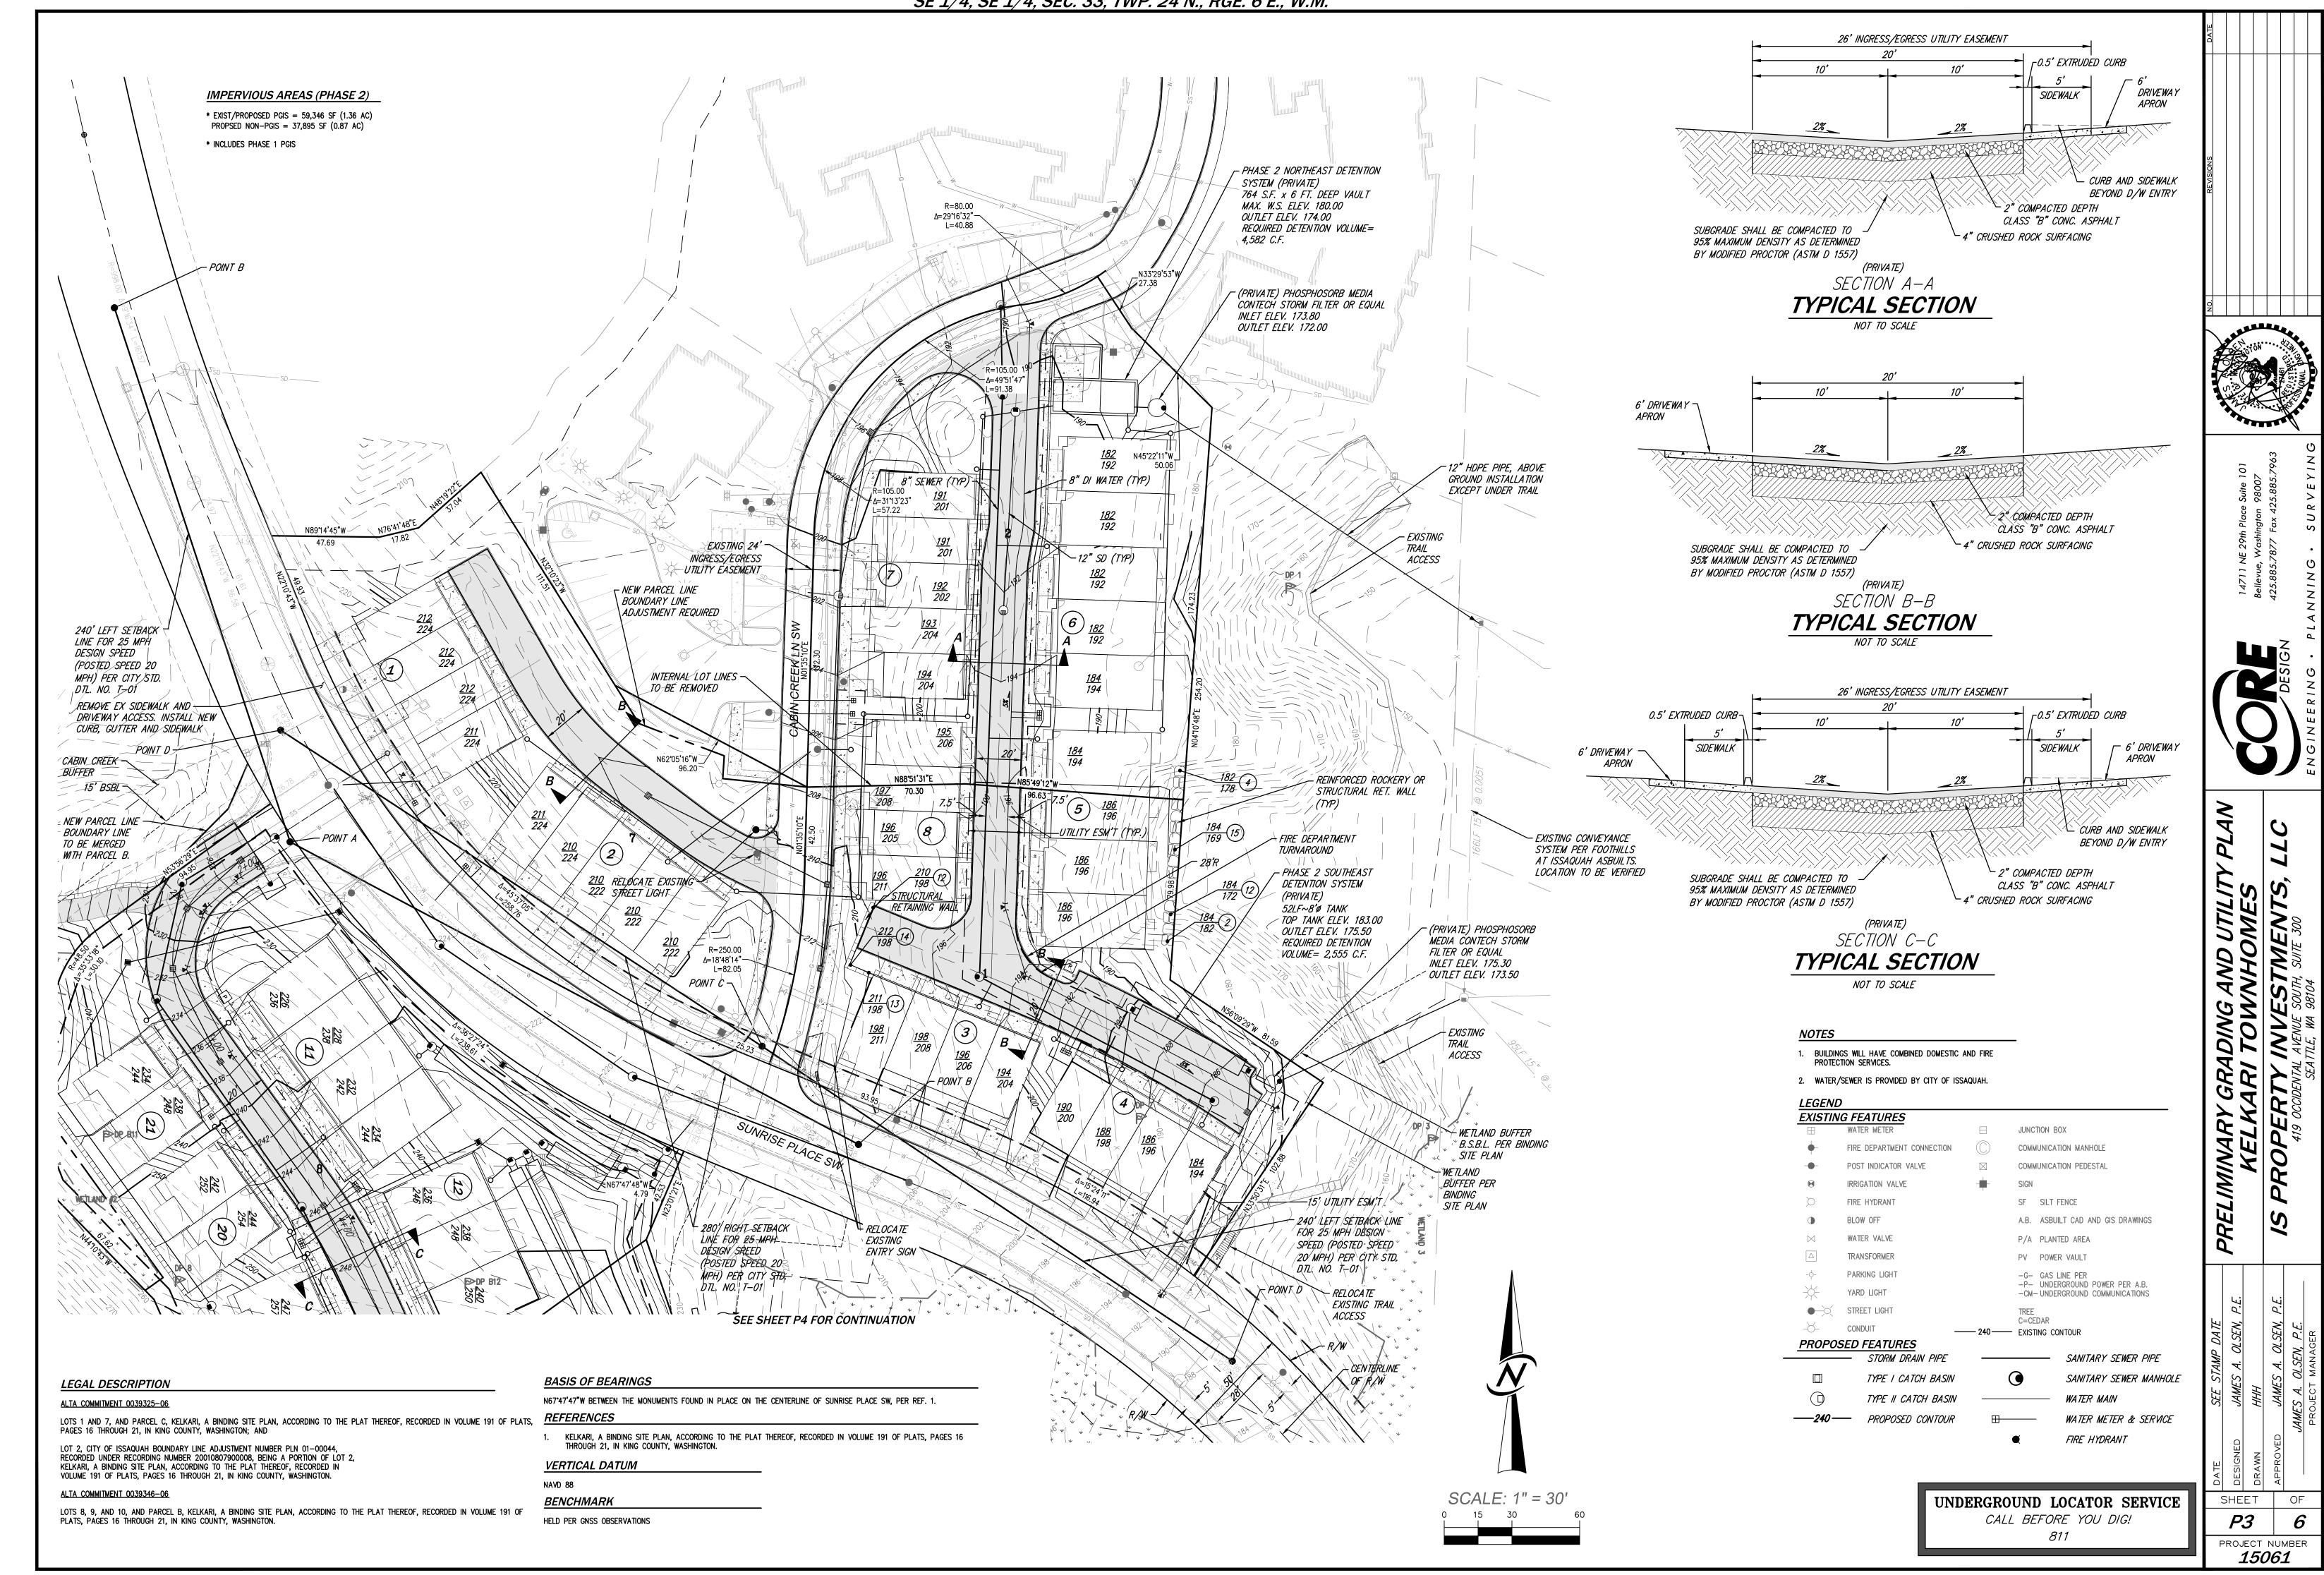
JAMES A. OLSEN
PROJECT MANAGER

DESIGNED


APPROVED

AMES A.


PROJECT NUMBER



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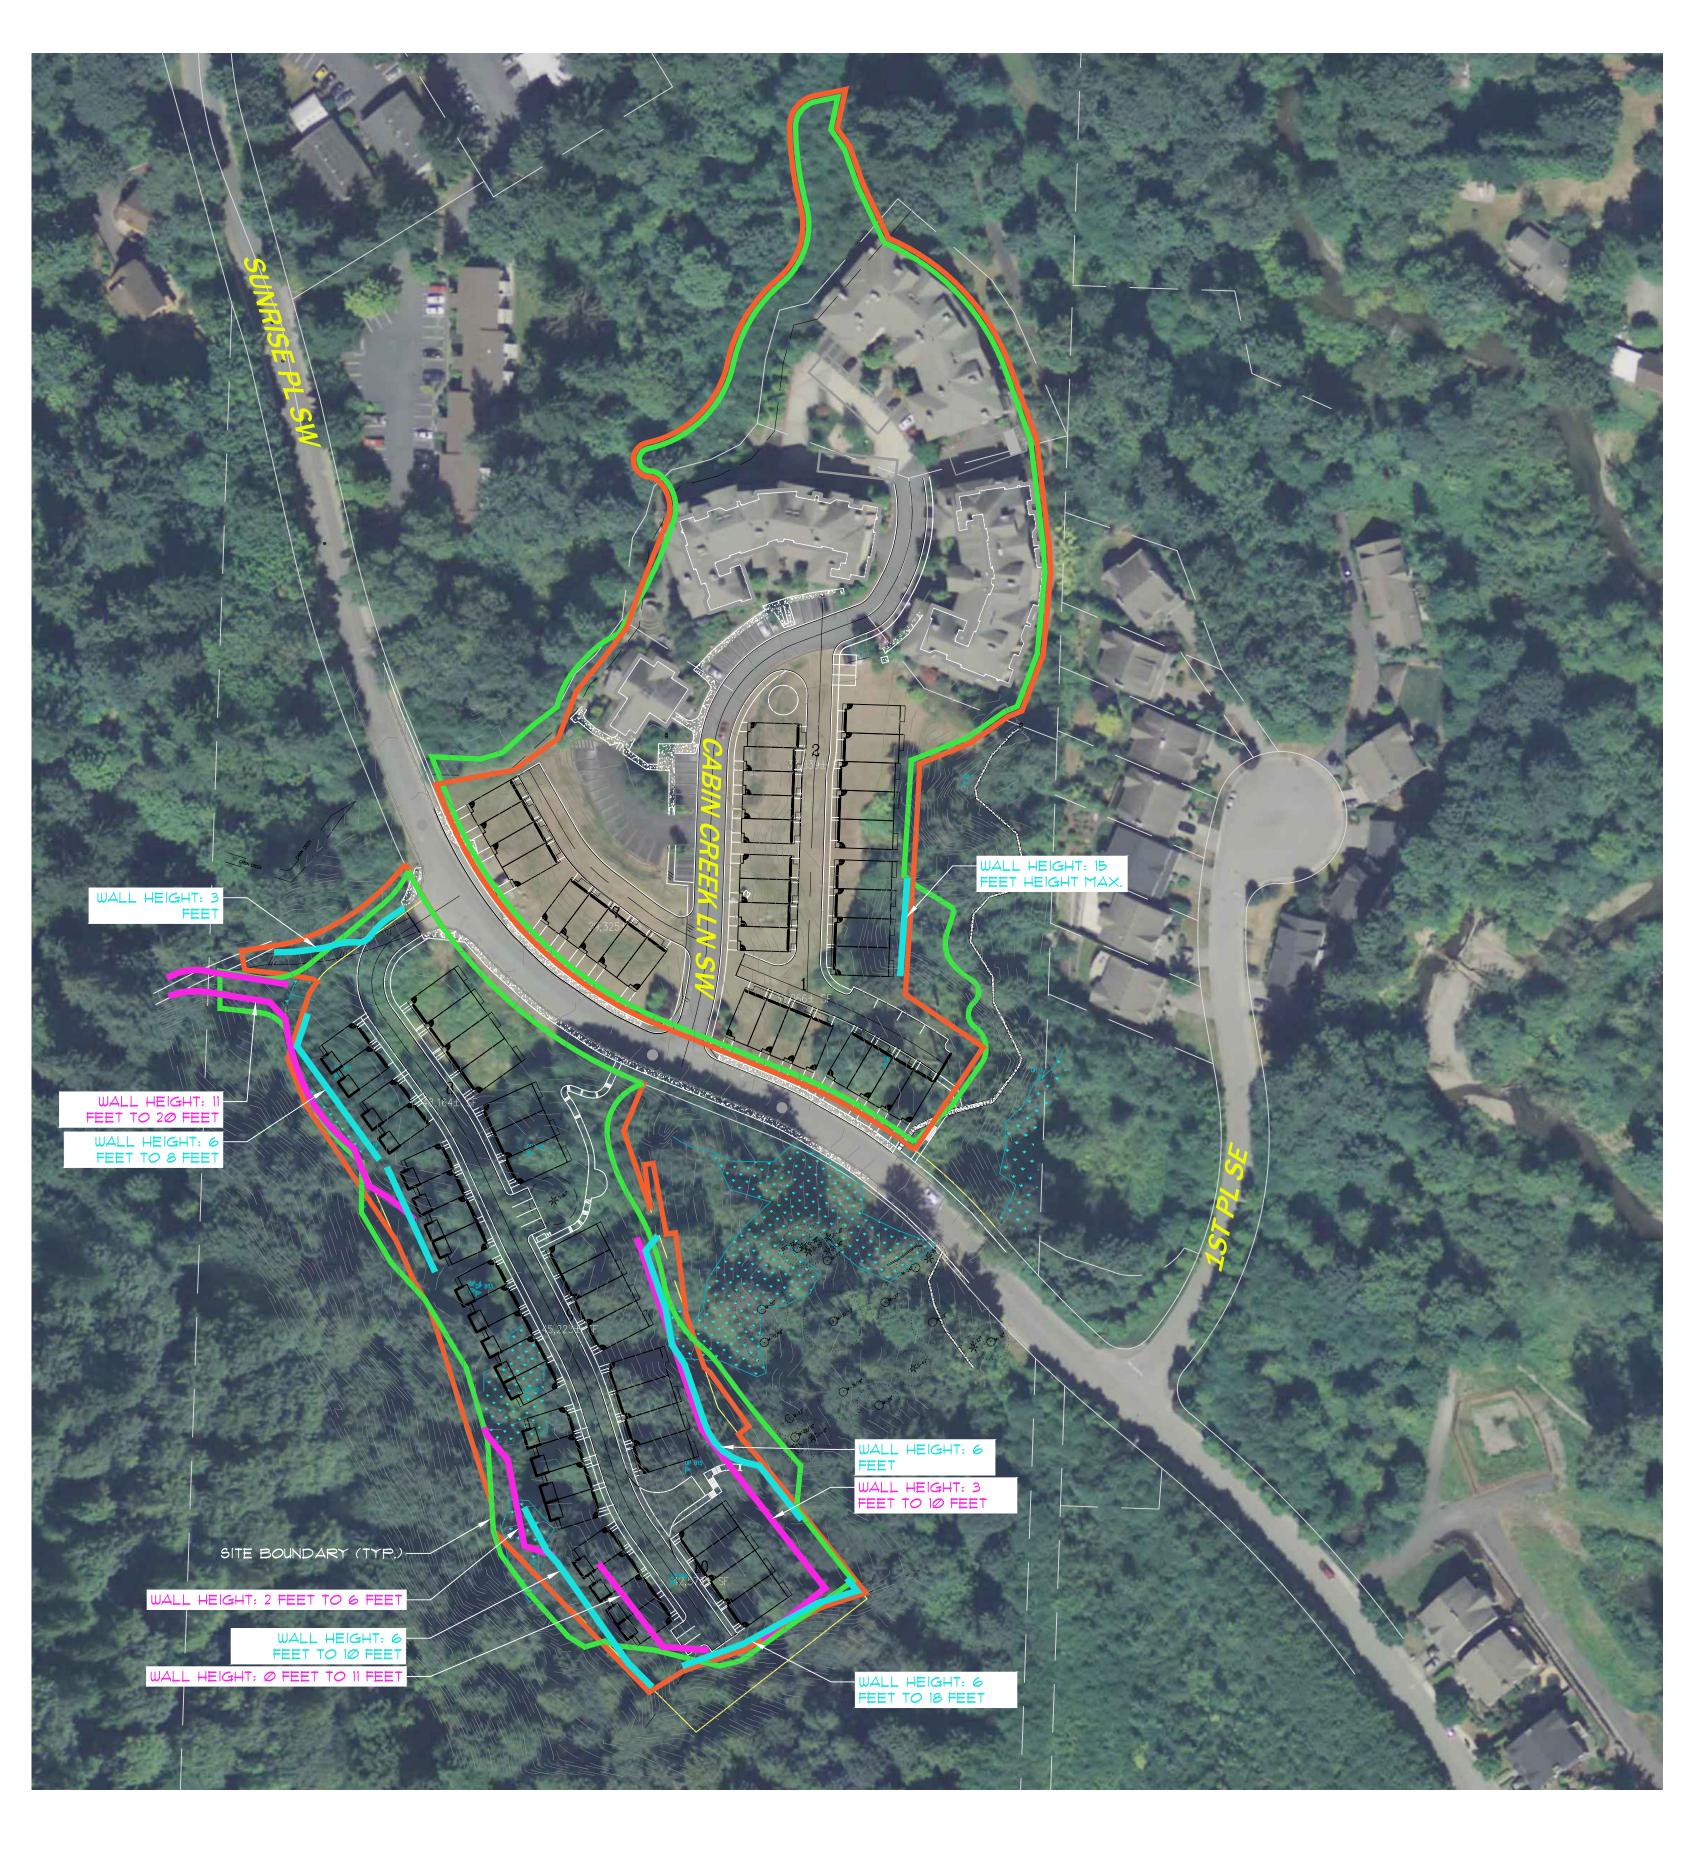

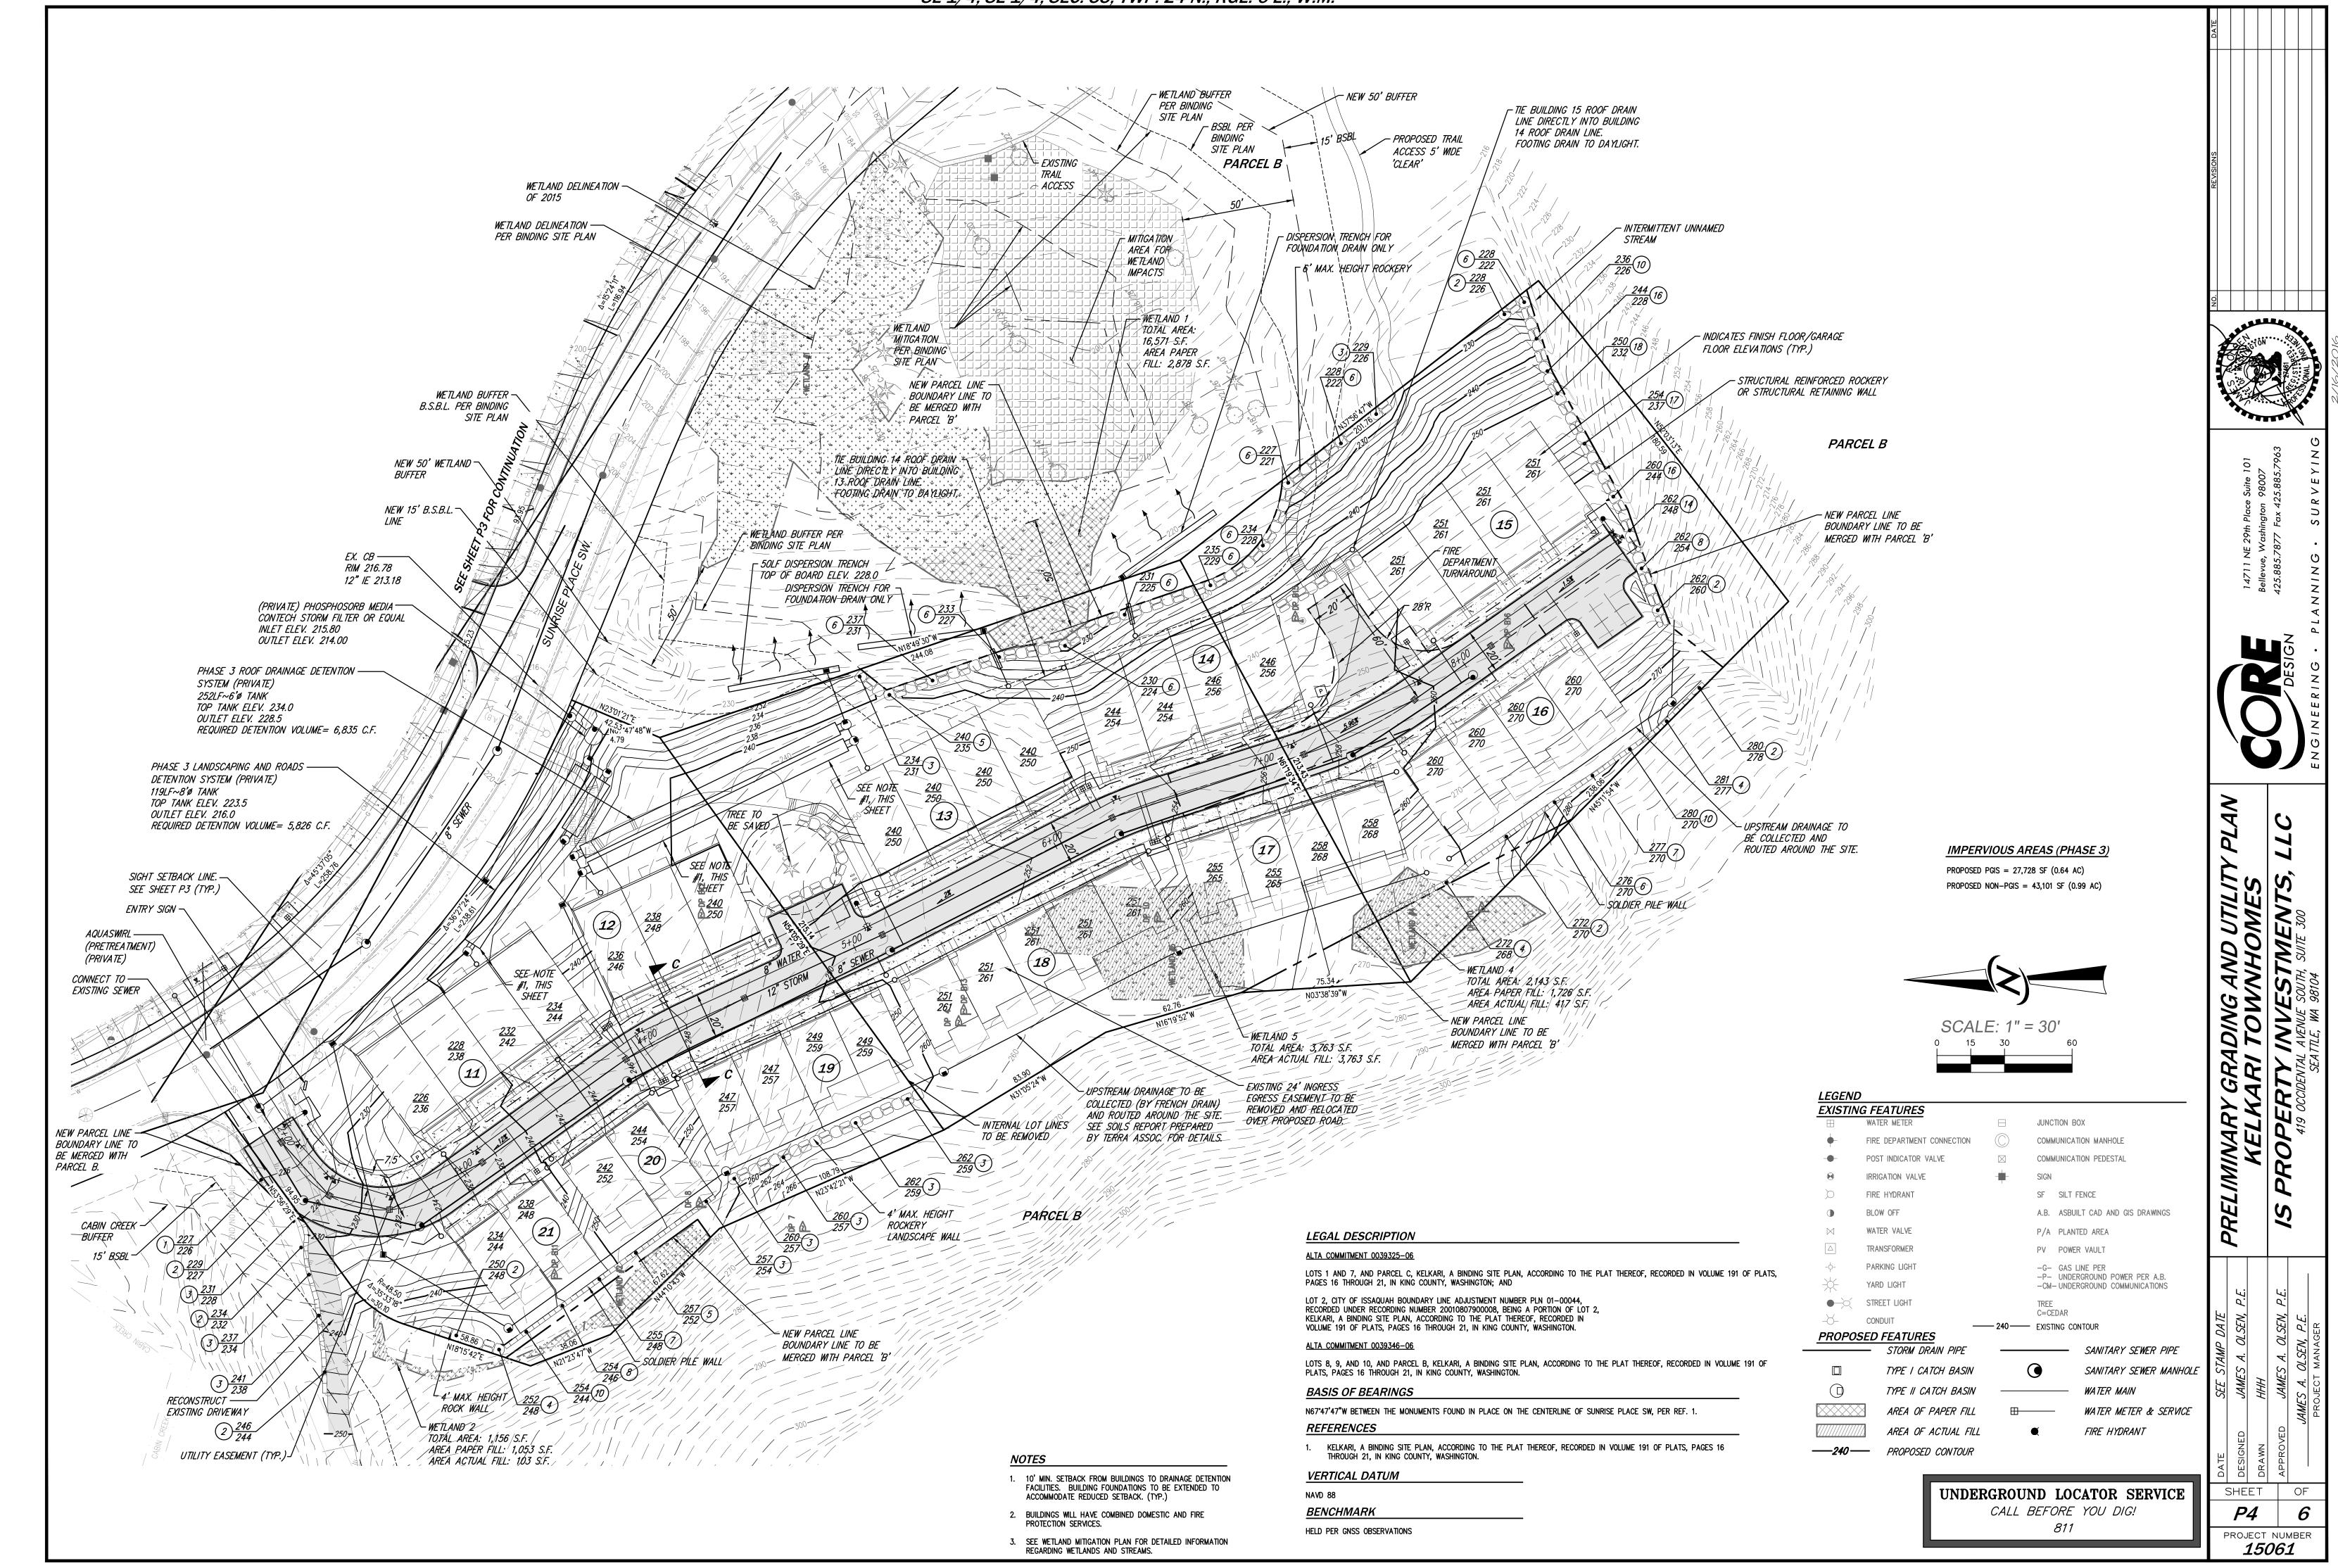
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SITE DISTURBANCE EXHIBIT

SITE DISTURBANCE SUMMARY

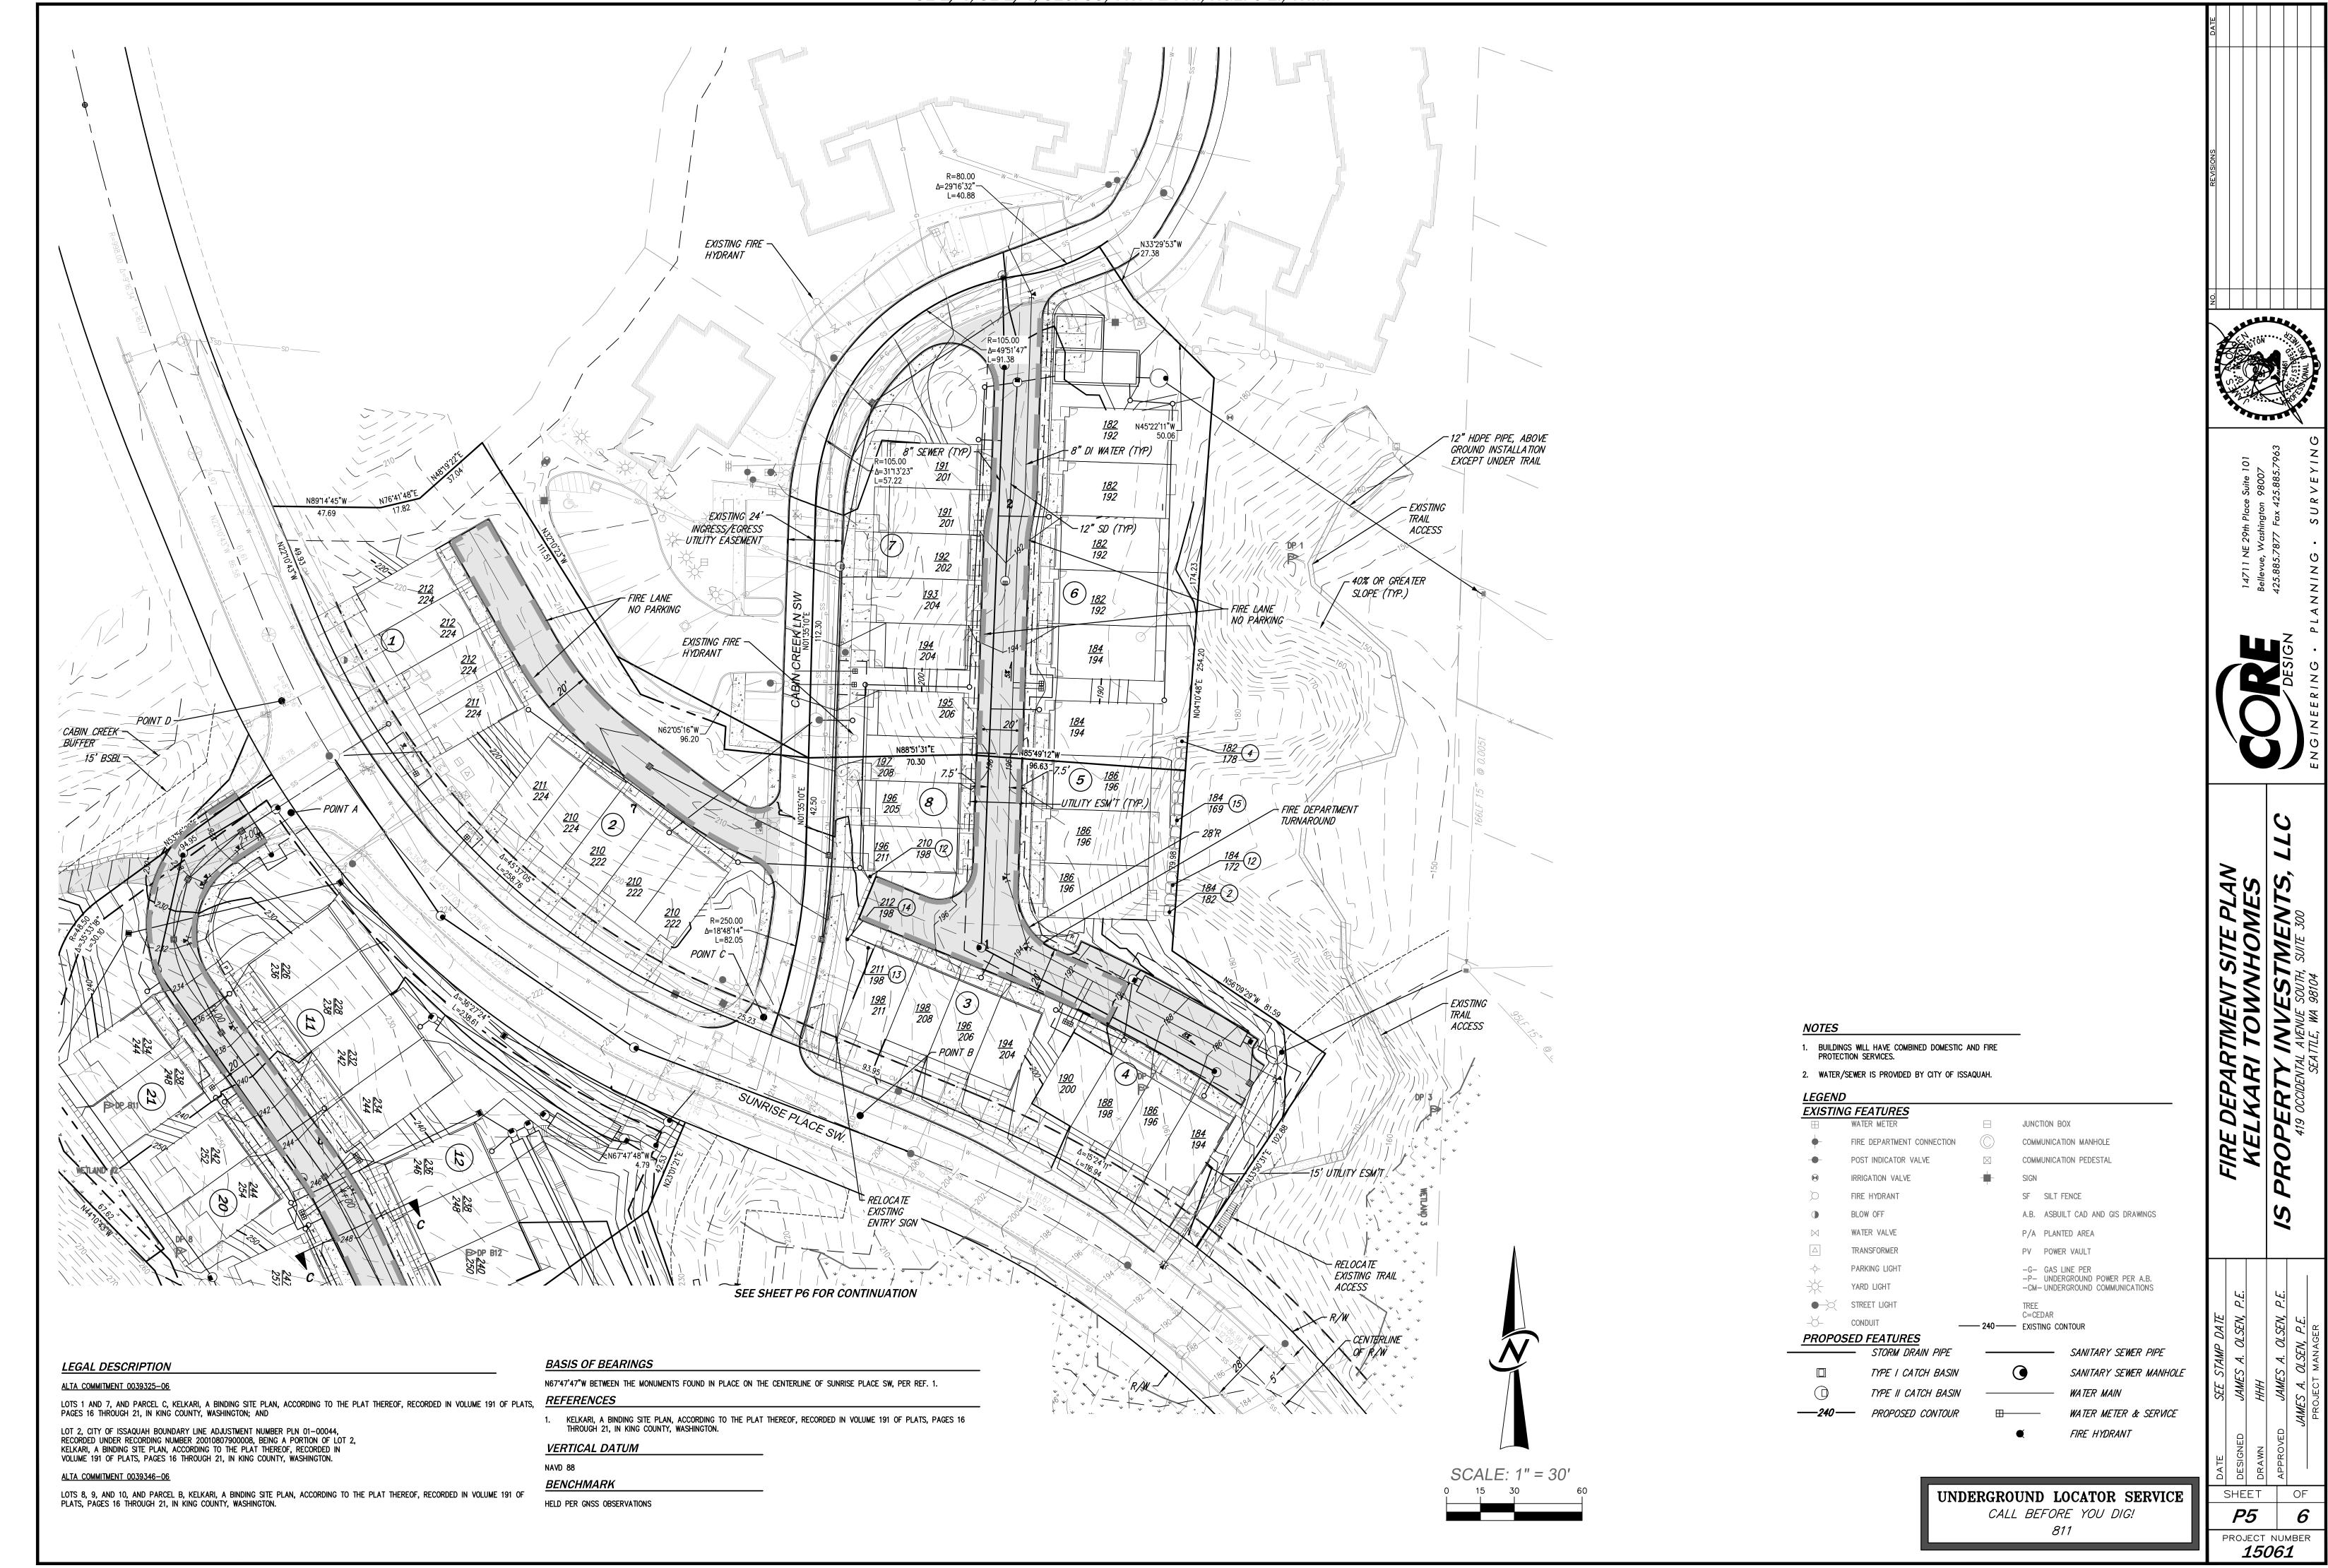PREVIOUSLY PROPOSED AREA OF DISTURBANCE 364,983 SF (8.37 AC)

CURRENTLY PROPOSED AREA OF DISTURBANCE


CURRENTLY PROPOSED AREA OF DISTURBANCE 356,386 SF (8.18 AC)

LOCATION OF PREVIOUSLY APPROVED RETAINING WALLS (Ø FEET TO 20 FEET)


LOCATION OF CURRENTLY PROPOSED RETAINING WALLS (3 FEET TO 18 FEET)


KELKARI TOWNHOMES
ISSAQUAH, WASHINGTON


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# ISSAQUAH KELKARI

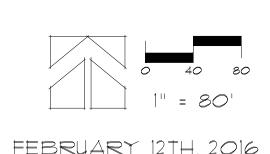



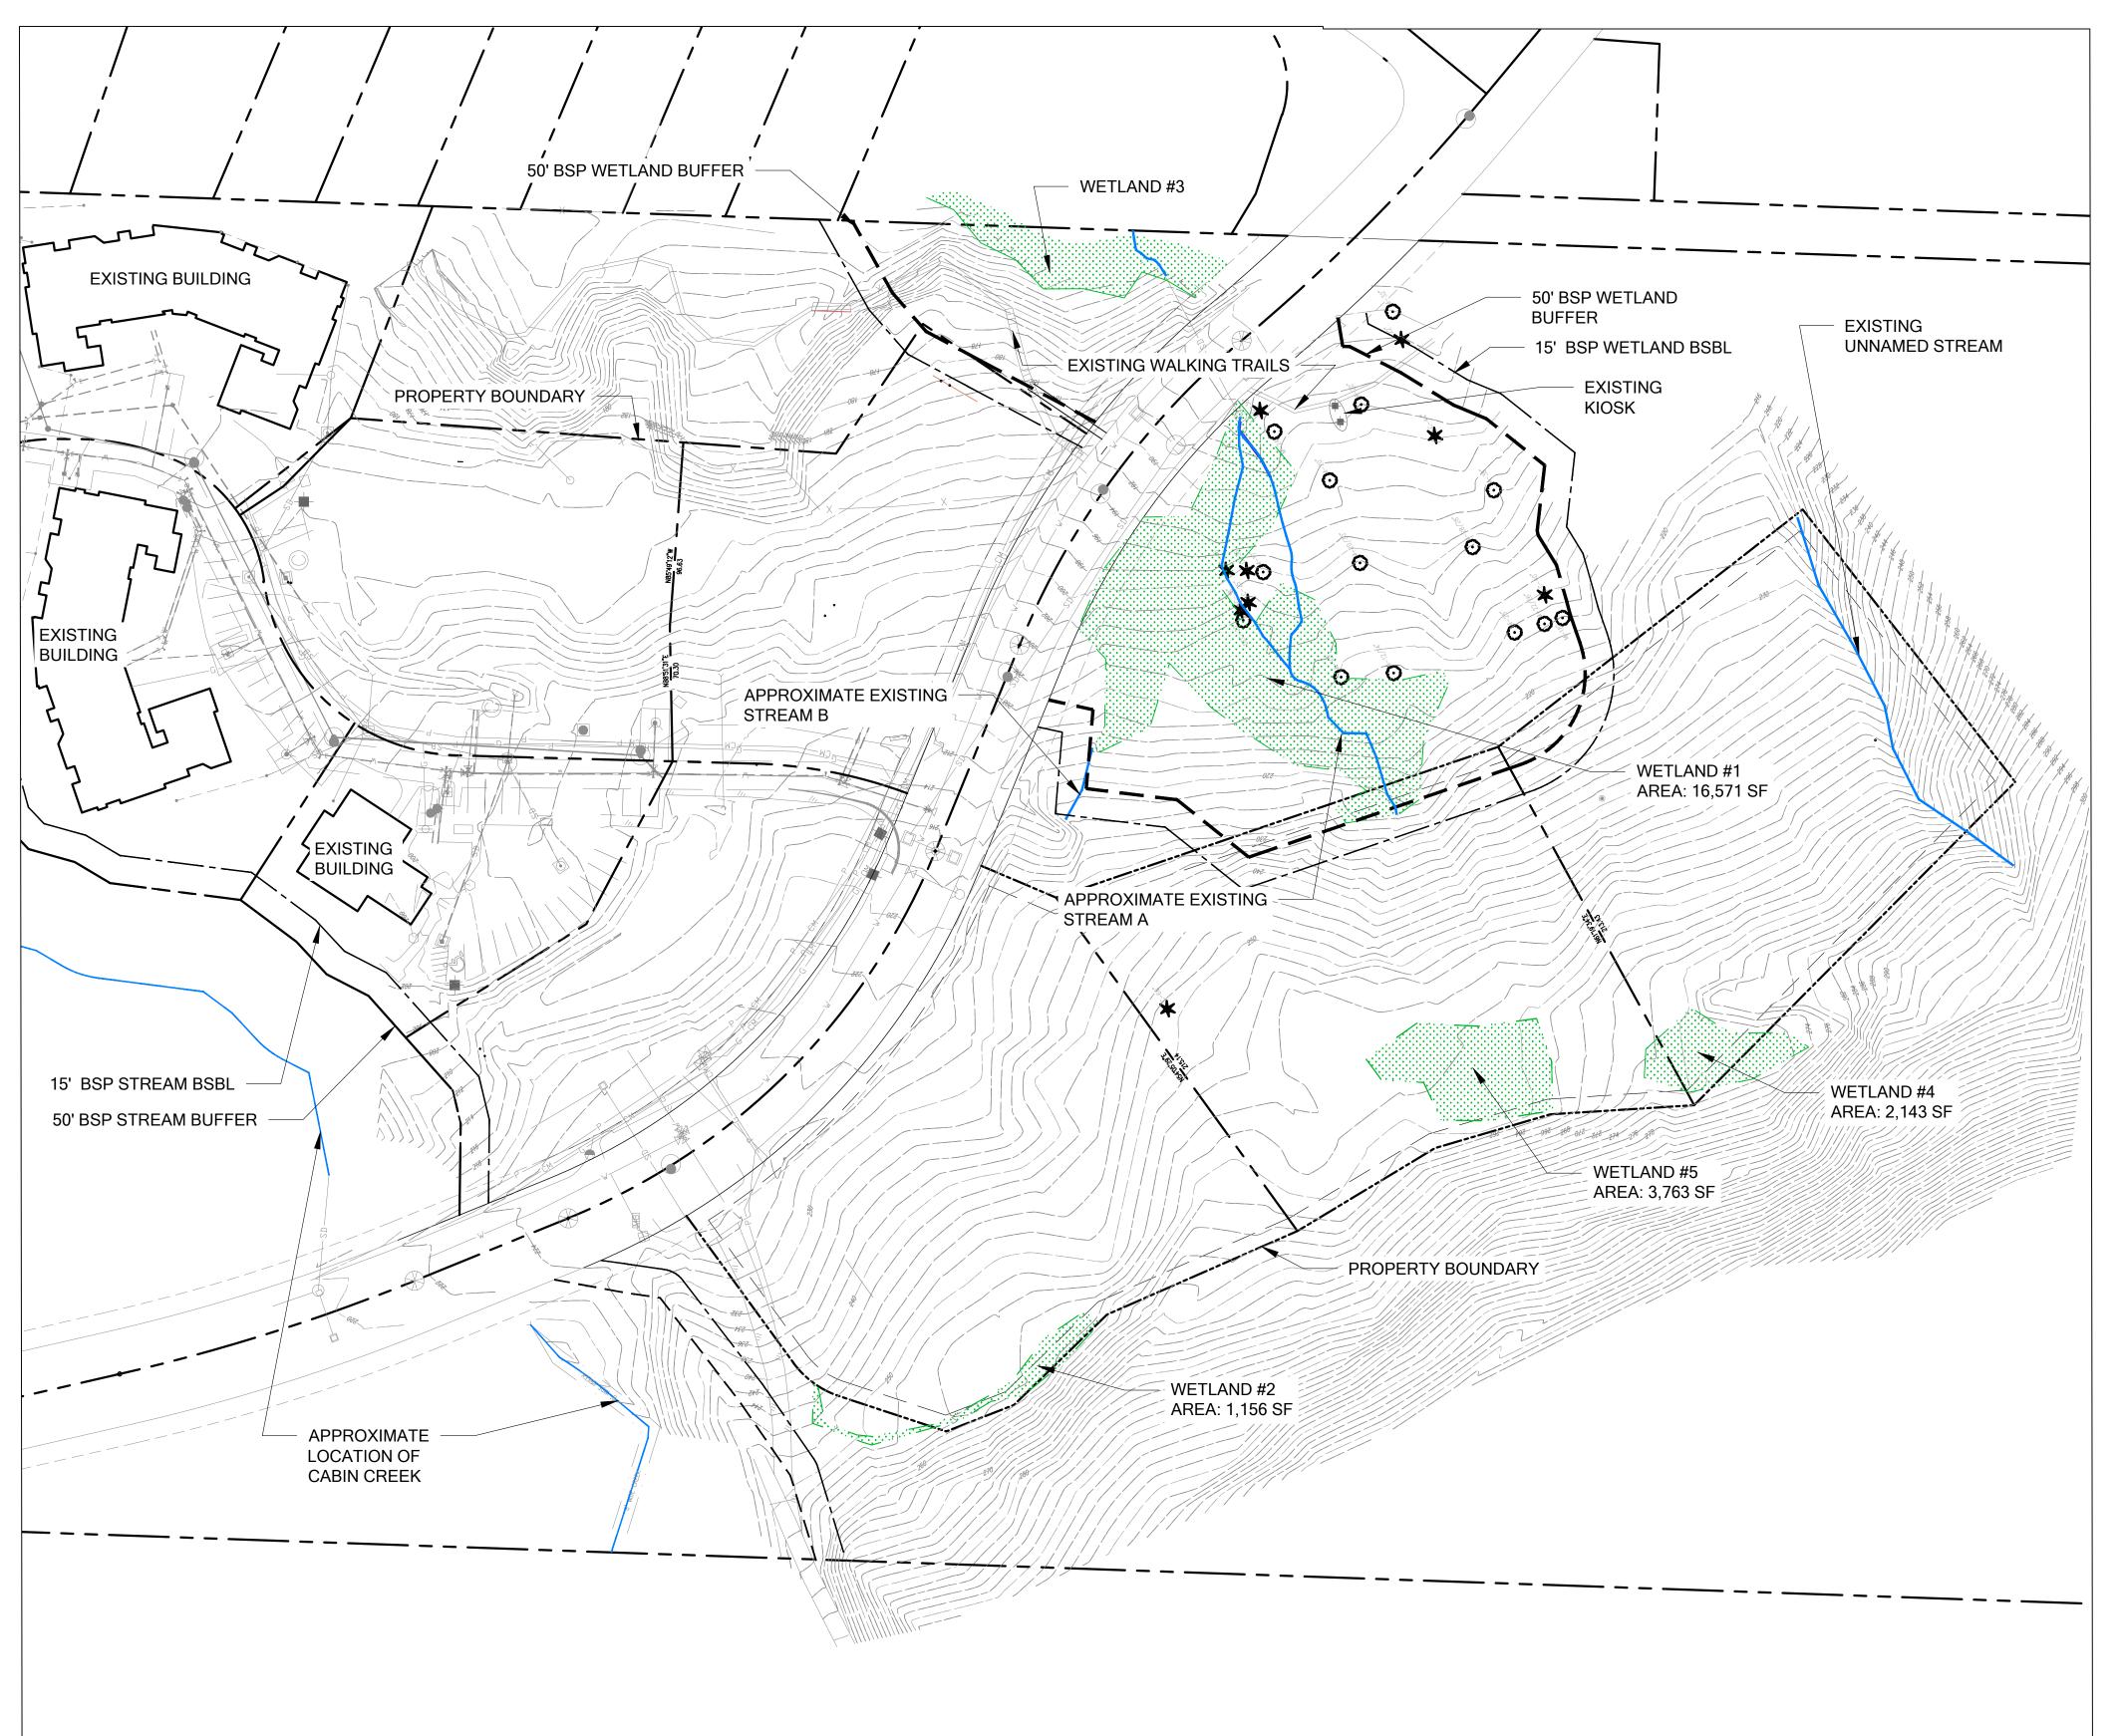
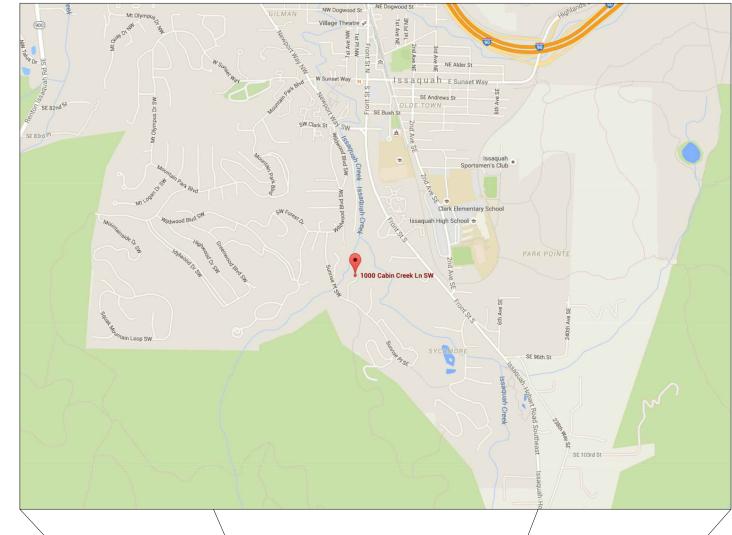
# **VICINITY MAPS**
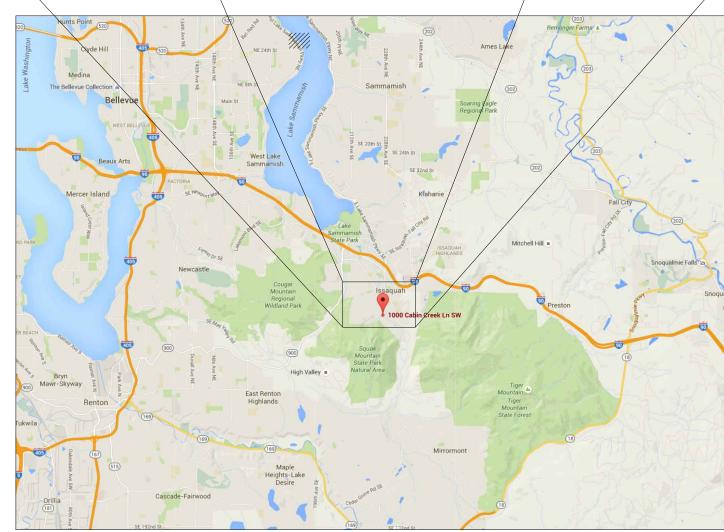
# LEGEND

WETLAND BOUNDARY, DELINEATED.

— BSP WETLAND BUFFER

— - — BSP WETLAND OR STREAM BSBL

— — — BSP STREAM BUFFER

APPROXIMATE EXISTING STREAM

# **SHEET INDEX**

W1 EXISTING CONDITIONS

W2 IMPACTS AND MITIGATION AREA

W3 TESC PLAN W4 MITIGATION PLAN

W5 GRADING PLAN

W6 PLANTING PLAN

W7 DETAILS AND NOTES (1 OF 2) W8 DETAILS AND NOTES (2 OF 2)

### NOTES

- 1. WETLANDS DELINEATED BY: THE WATERSHED COMPANY ON JULY 6,7,9, AND 16, 2015.
- 2. BASE FILE RECEIVED FROM CORE DESIGN INC. ON DECEMBER 17TH, 2015.
- 3. BSP: BINDING SITE PLAN
- 4. BSBL: BUILDING SET BACK LINE

— -- PARCEL BOUNDARIES

**IS PROPERTY INVESTMENTS LLC** 

PLOT DATE:

SDP/ MSP/ BSP MINOR **AMENDMENT APPLICATION** 2-12-16

SDP/ MSP/ BSP MINOR AMENDMENT APPLICATION



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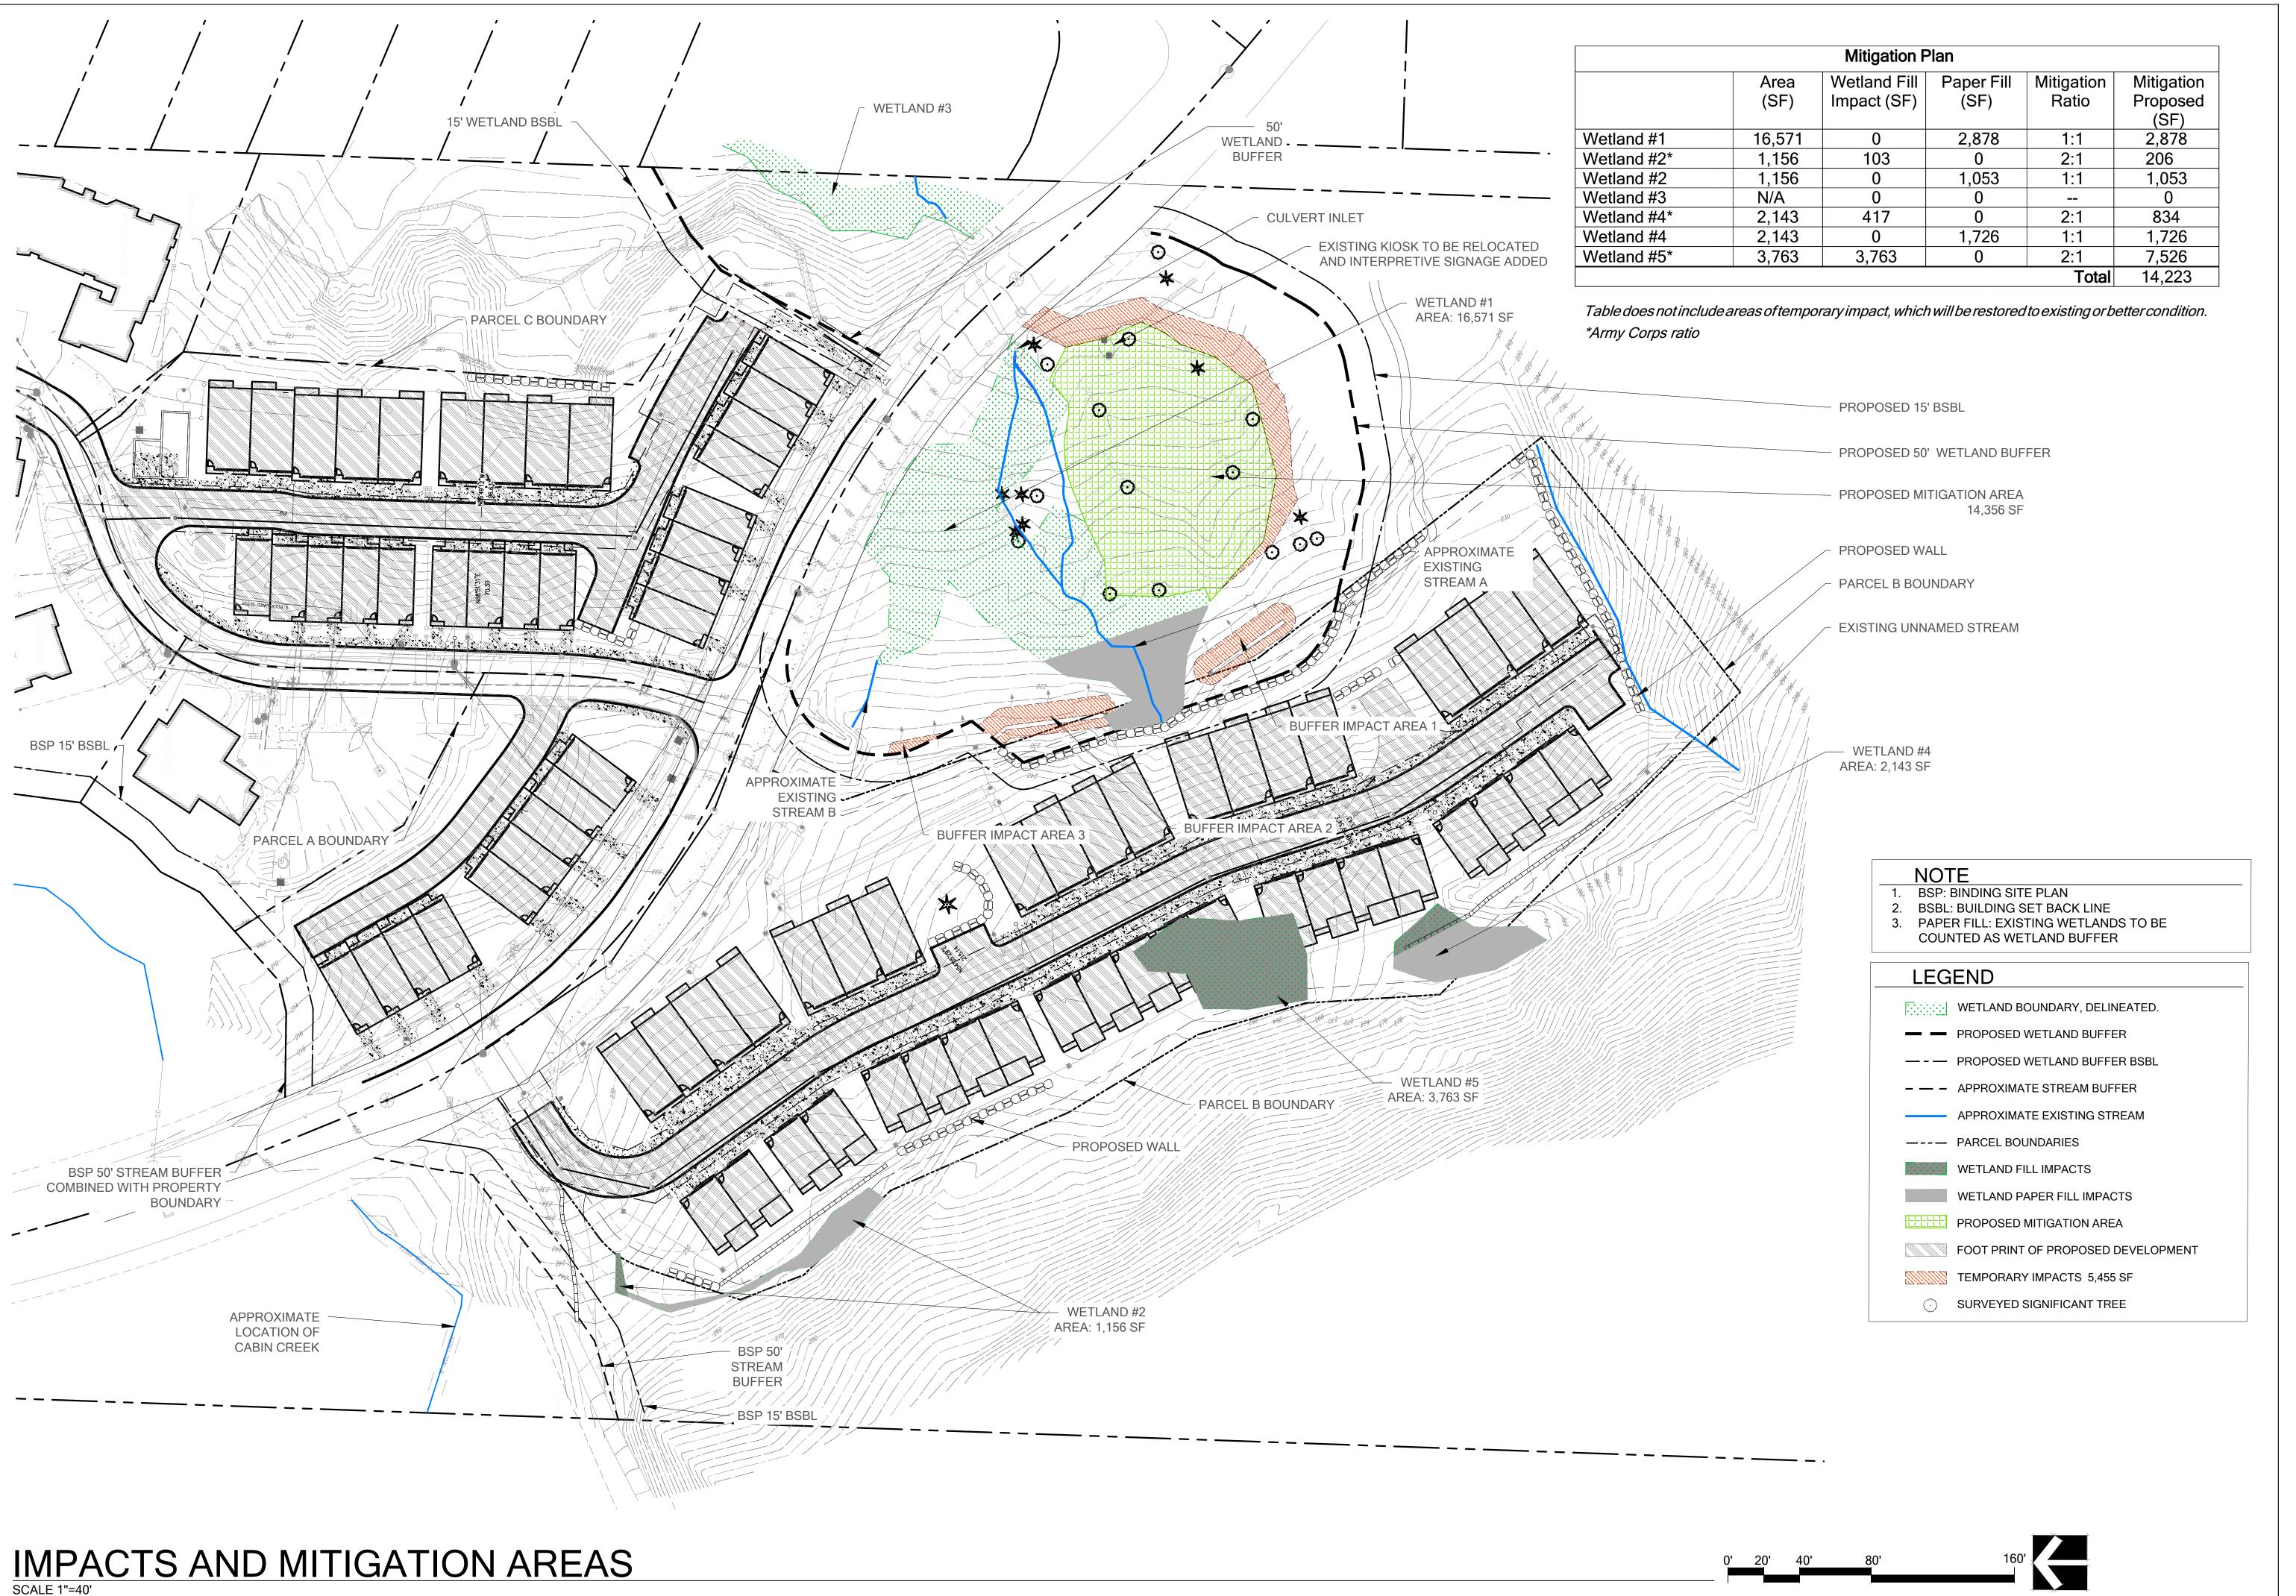
SHEET SIZE 24X36

MITIGATION PLAN

W1 OF 8

**EXISTING CONDITIONS** 





# SUNRISE PL. S.W.

IS PROPERTY
INVESTMENTS LLC

PROJECT NUMBER: 15-0357
PROJECT MANAGER: JG
DRAWN BY: KMB
PLOT DATE: 2-12-10

SDP/ MSP/ BSP MINOR AMENDMENT APPLICATION 2-12-16

REVISIONS:

FEBRUARY 12, 2016 SDP/ MSP/ BSP MINOR AMENDMENT APPLICATION




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MITIGATION PLAN

W2 OF 8



SCALE 1"=20'

IS PROPERTY INVESTMENTS LLC

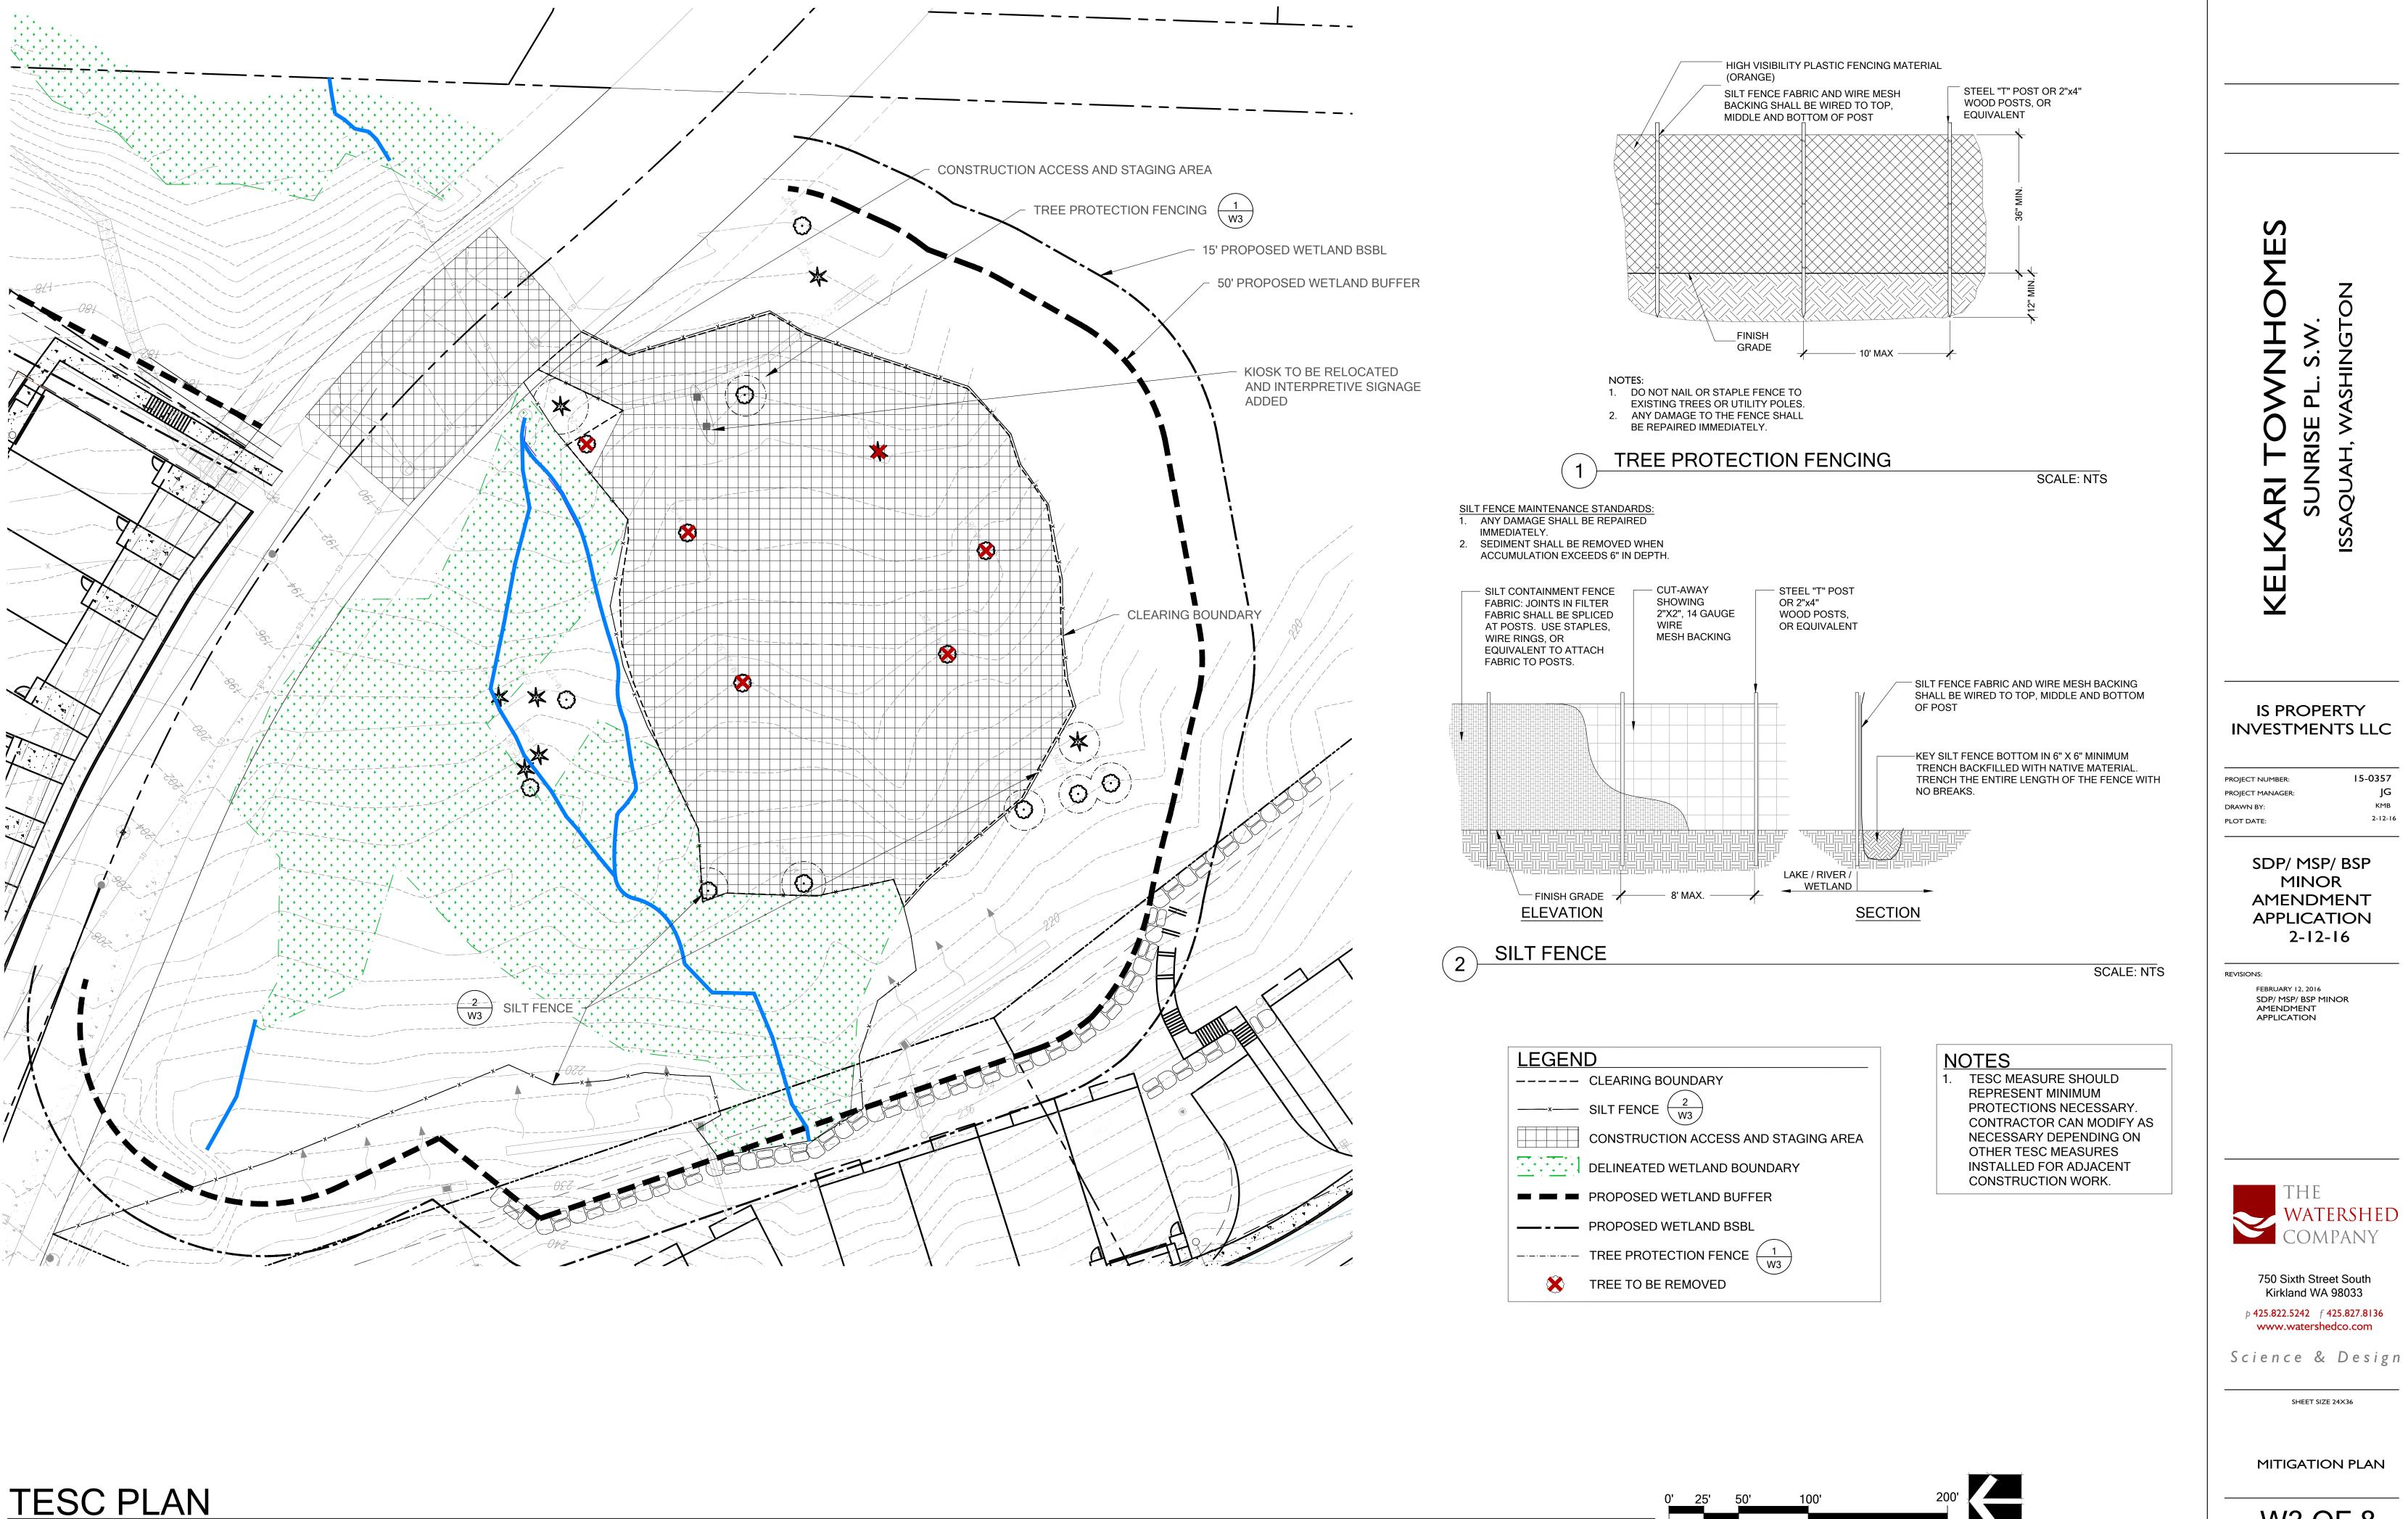15-0357 PROJECT NUMBER: PROJECT MANAGER: DRAWN BY: 2-12-16 PLOT DATE:

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REVISIONS: FEBRUARY 12, 2016

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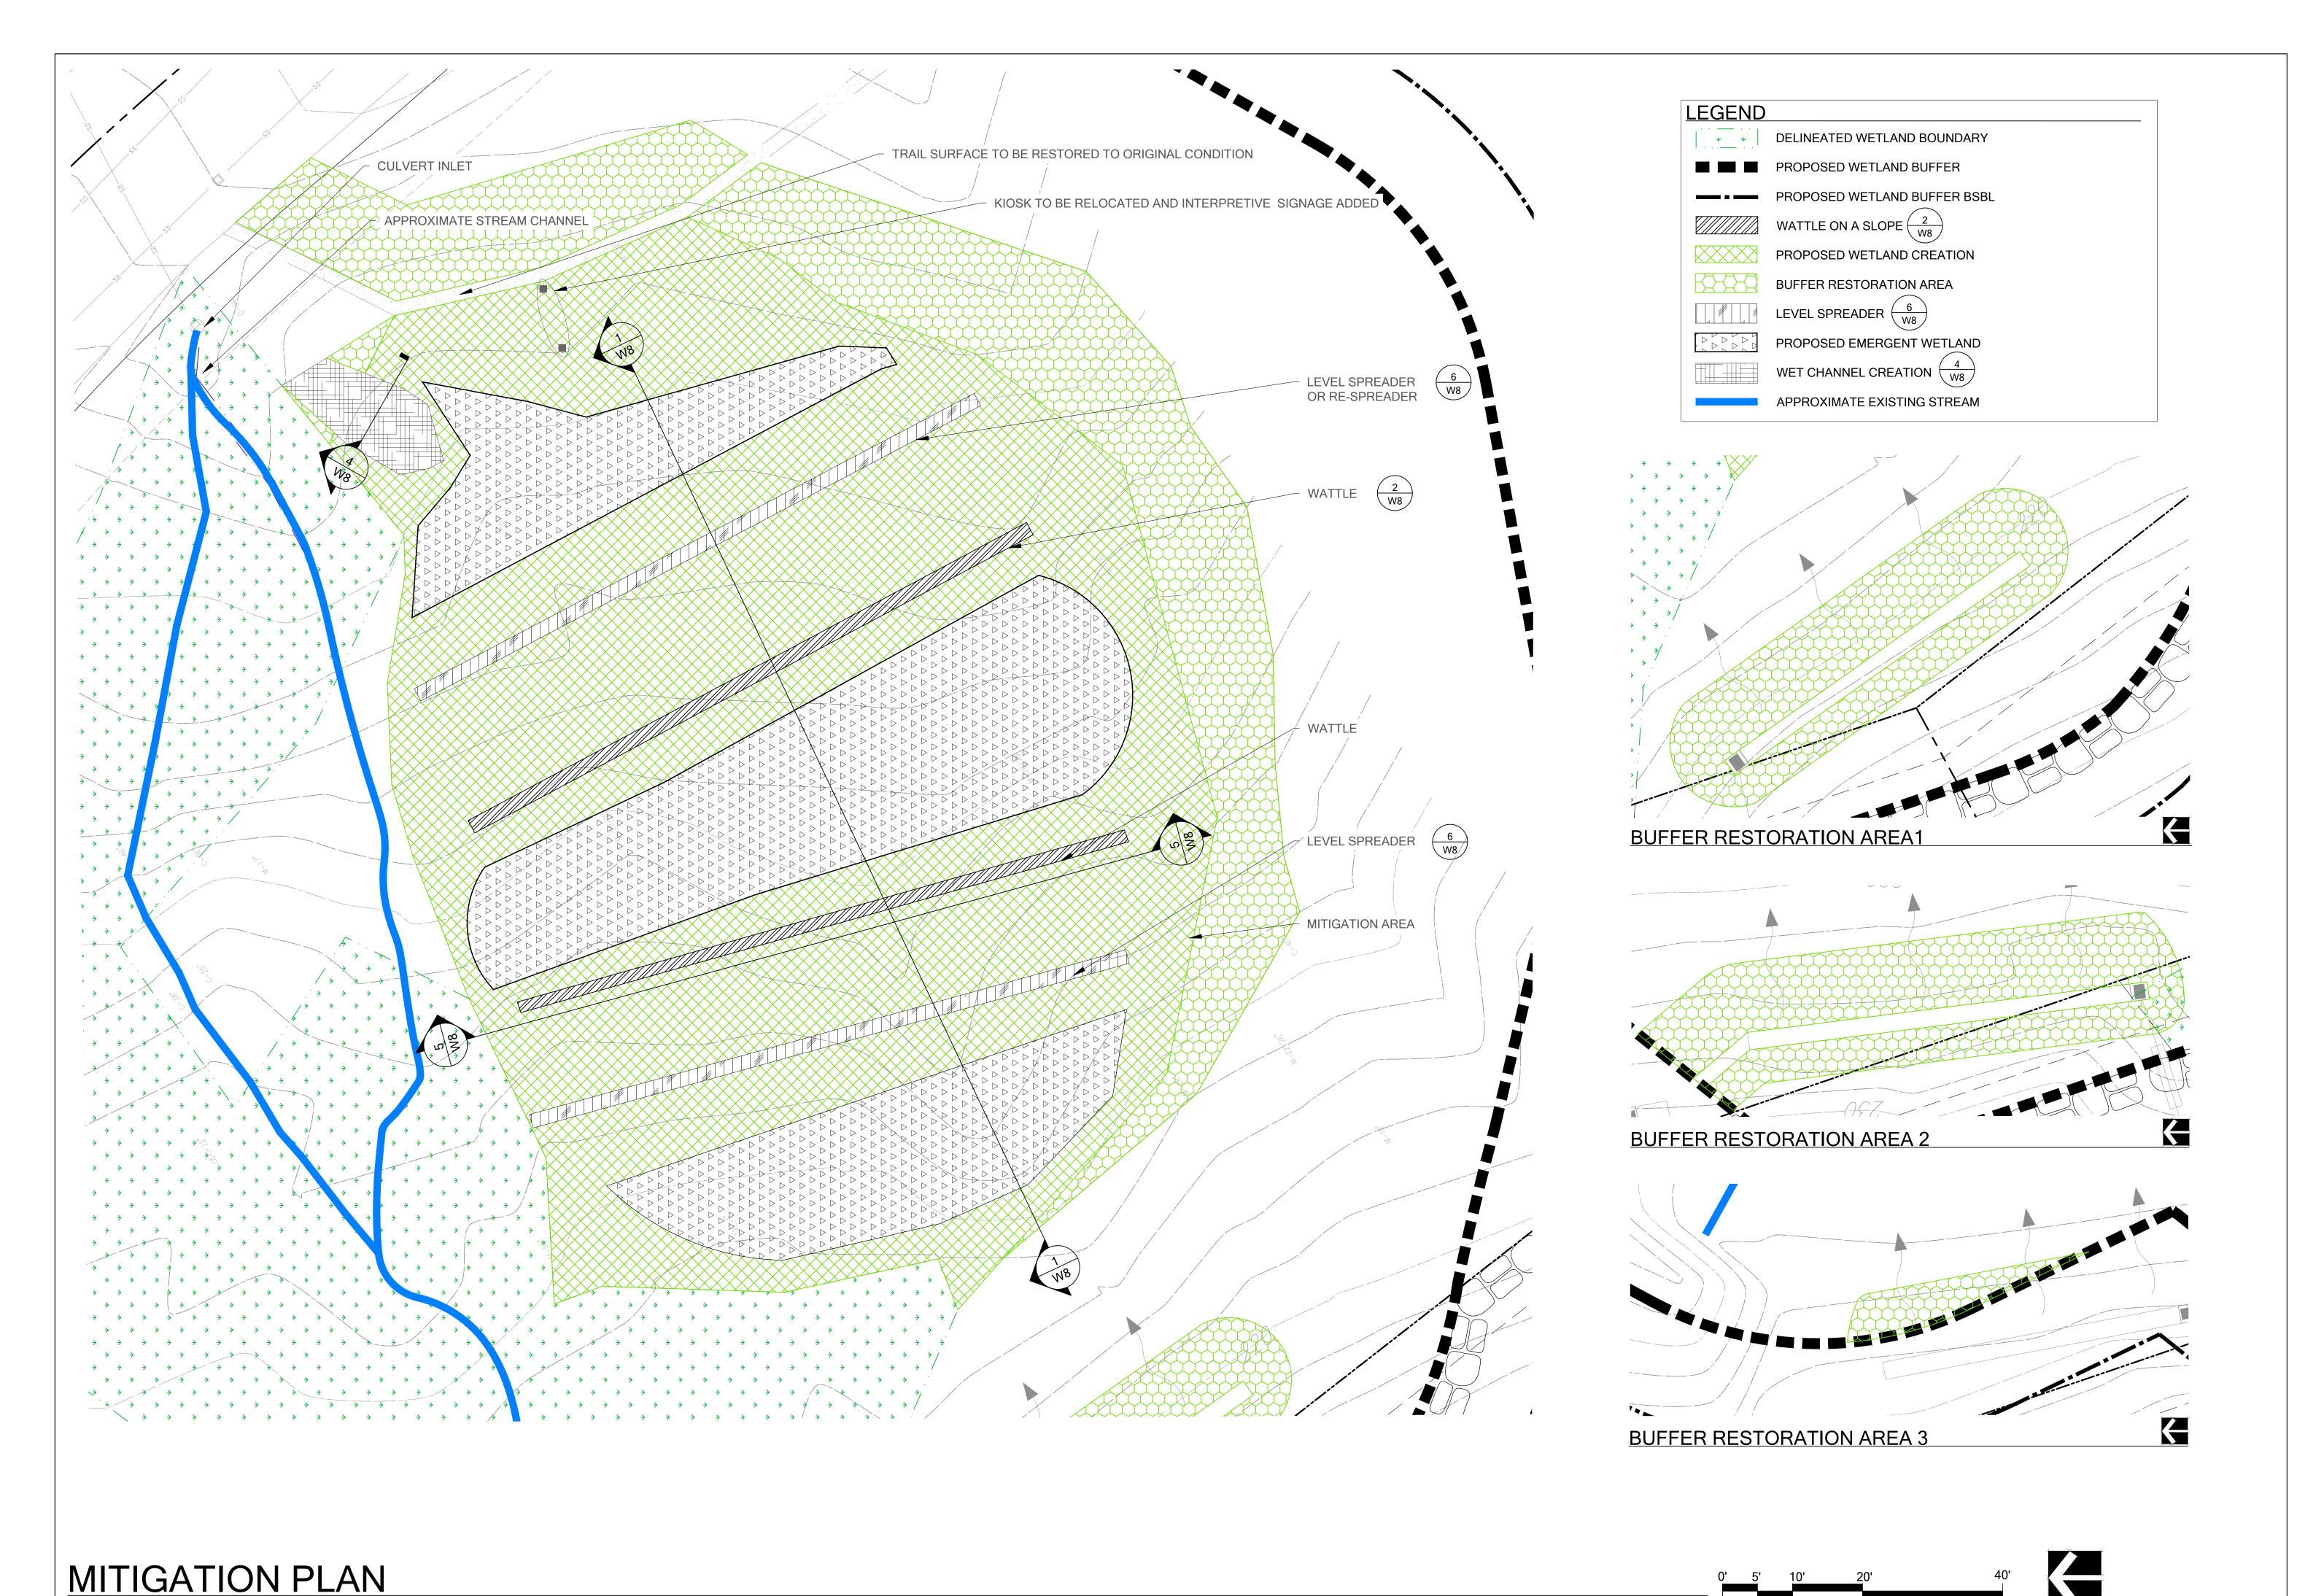
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SHEET SIZE 24X36

MITIGATION PLAN

W3 OF 8



SUNRISE PL. S.W.

IS PROPERTY
INVESTMENTS LLC

PROJECT NUMBER: 15-0357
PROJECT MANAGER: JC
DRAWN BY: KME
PLOT DATE: 2-12-

SDP/ MSP/ BSP MINOR AMENDMENT APPLICATION 2-12-16

visions: FEBRUARY 12, 2016 SDP/ MSP/ BSP MINOR

AMENDMENT APPLICATION




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SHEET SIZE 24×36

MITIGATION PLAN

W4 OF 8



# CELKARI TOWNHOMES SUNRISE PL. S.W.

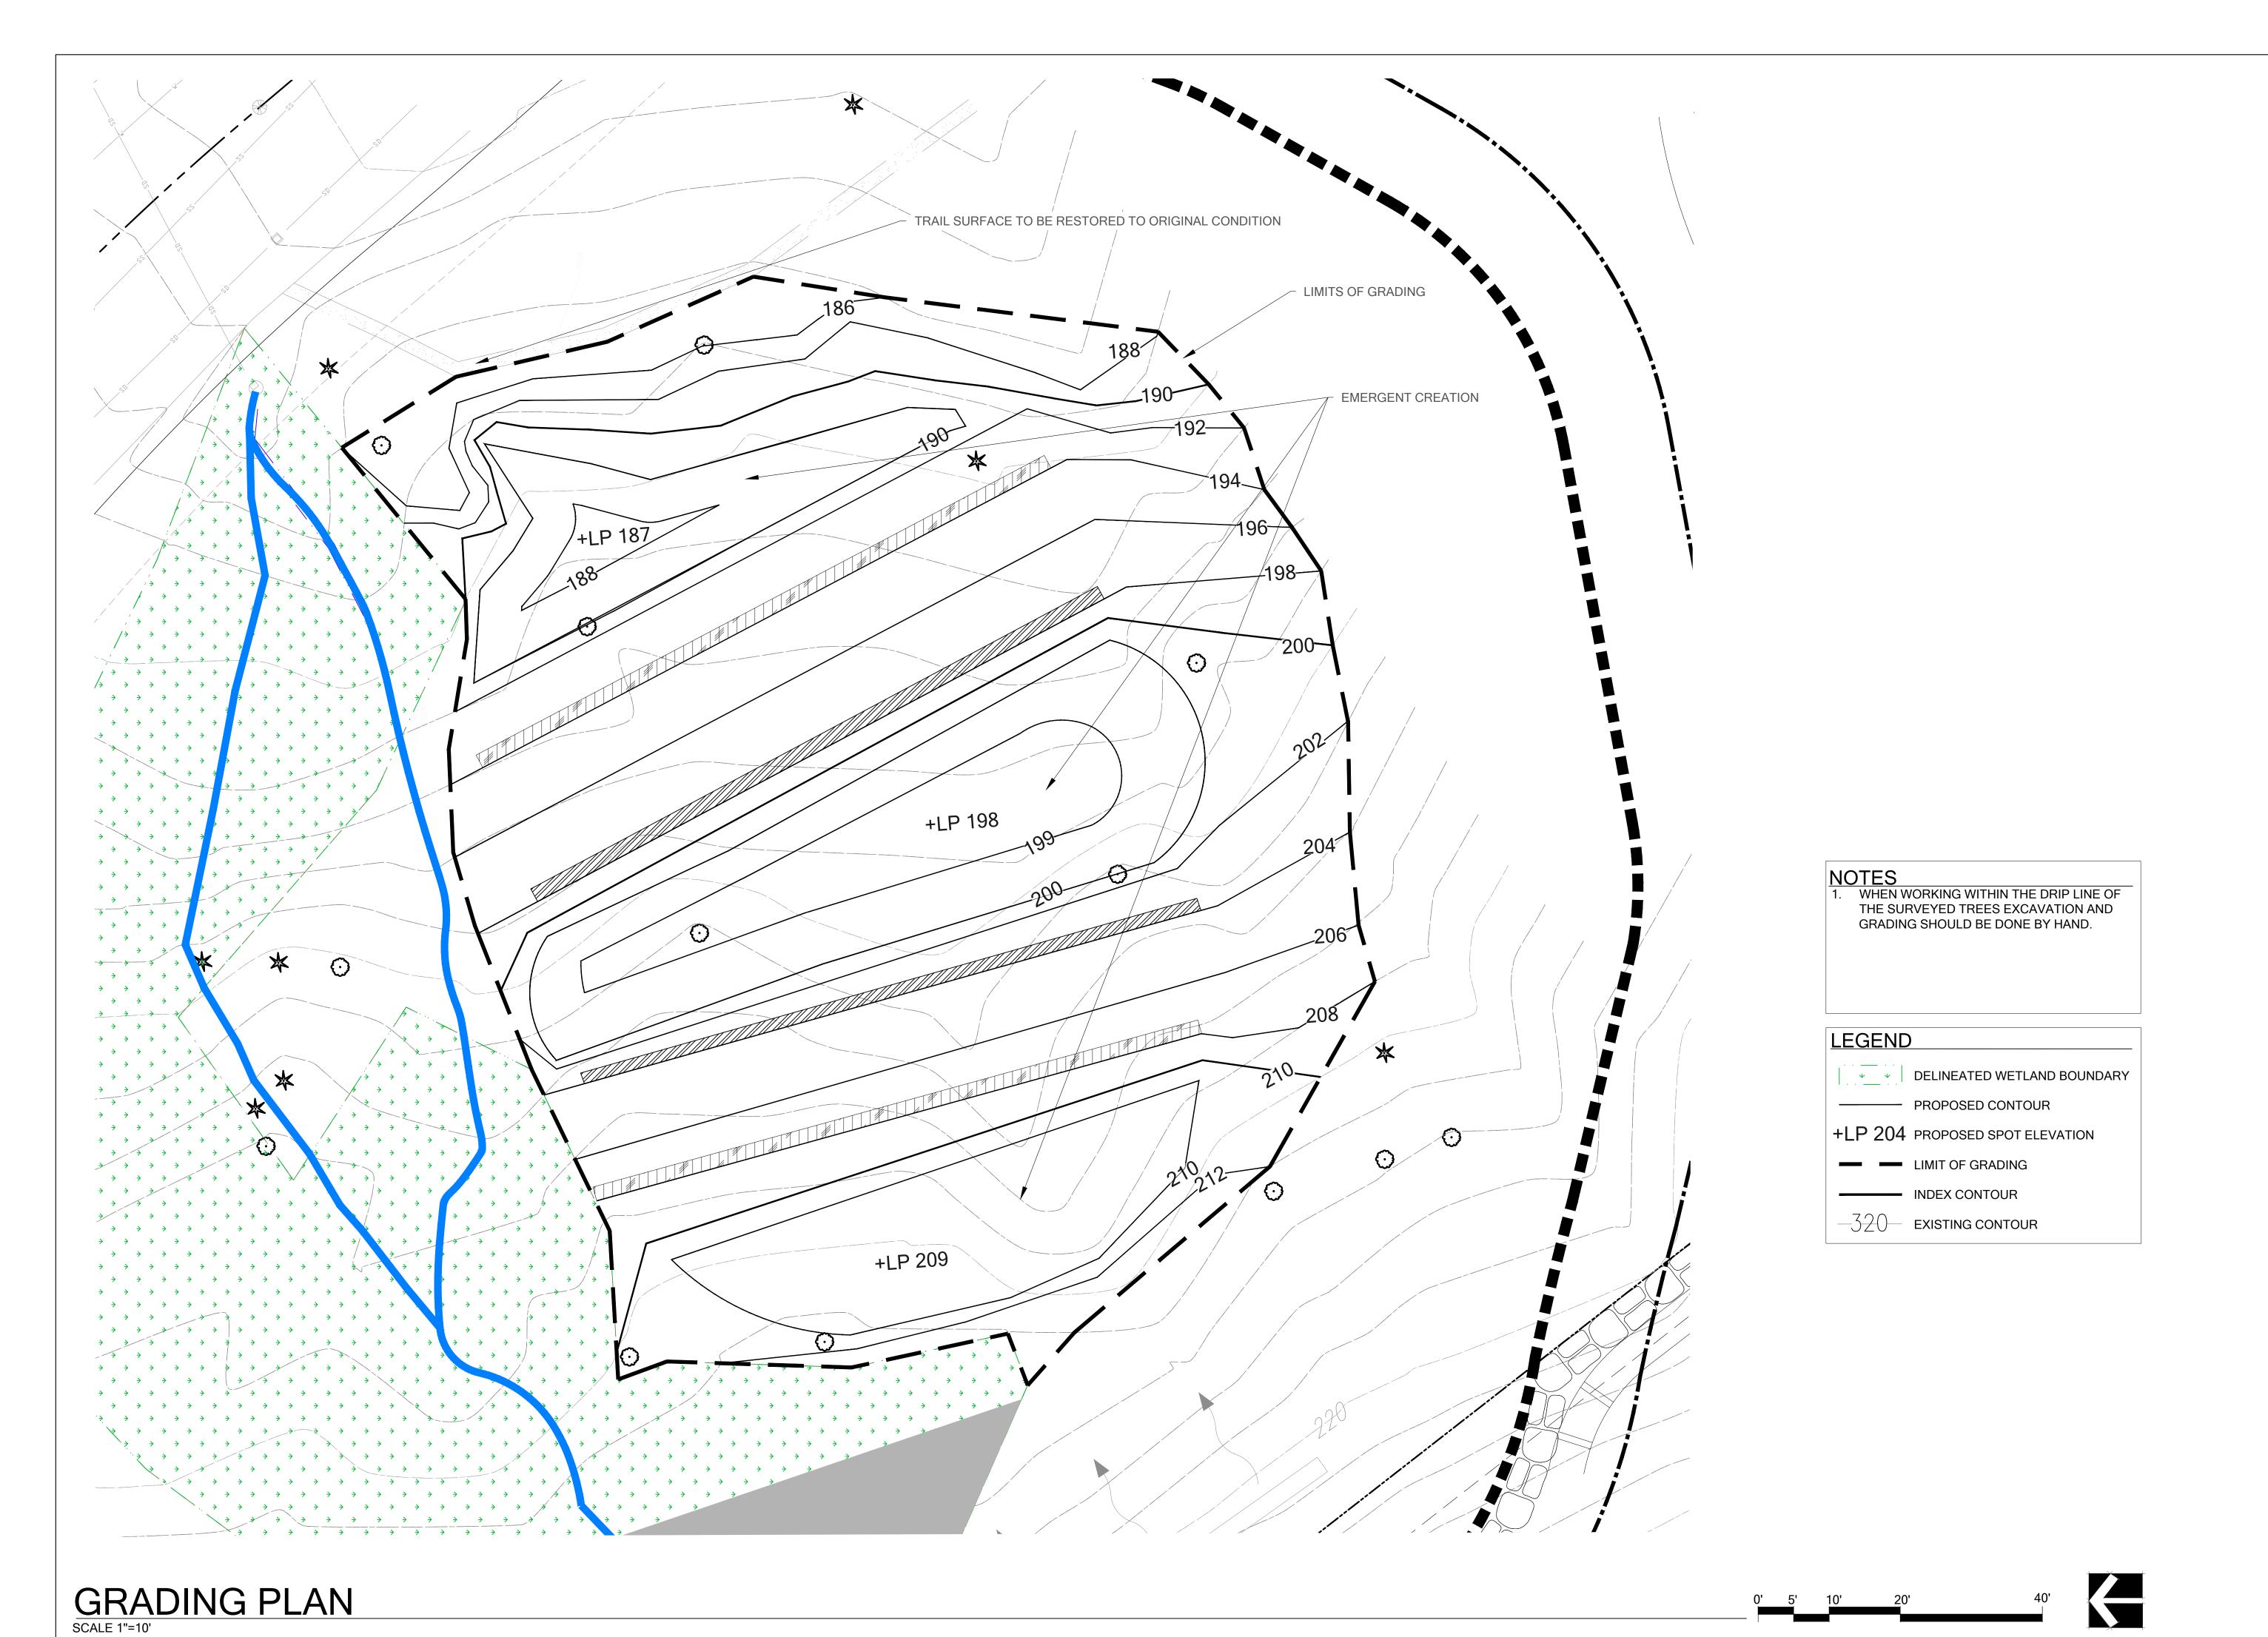IS PROPERTY
INVESTMENTS LLC

PROJECT NUMBER: 15-0357
PROJECT MANAGER: JG
DRAWN BY: KMB
PLOT DATE: 2-12-1

SDP/ MSP/ BSP MINOR AMENDMENT APPLICATION 2-12-16

REVISIONS:

FEBRUARY 12, 2016

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AMENDMENT

APPLICATION




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SHEET SIZE 24X36

MITIGATION PLAN

W5 OF 8



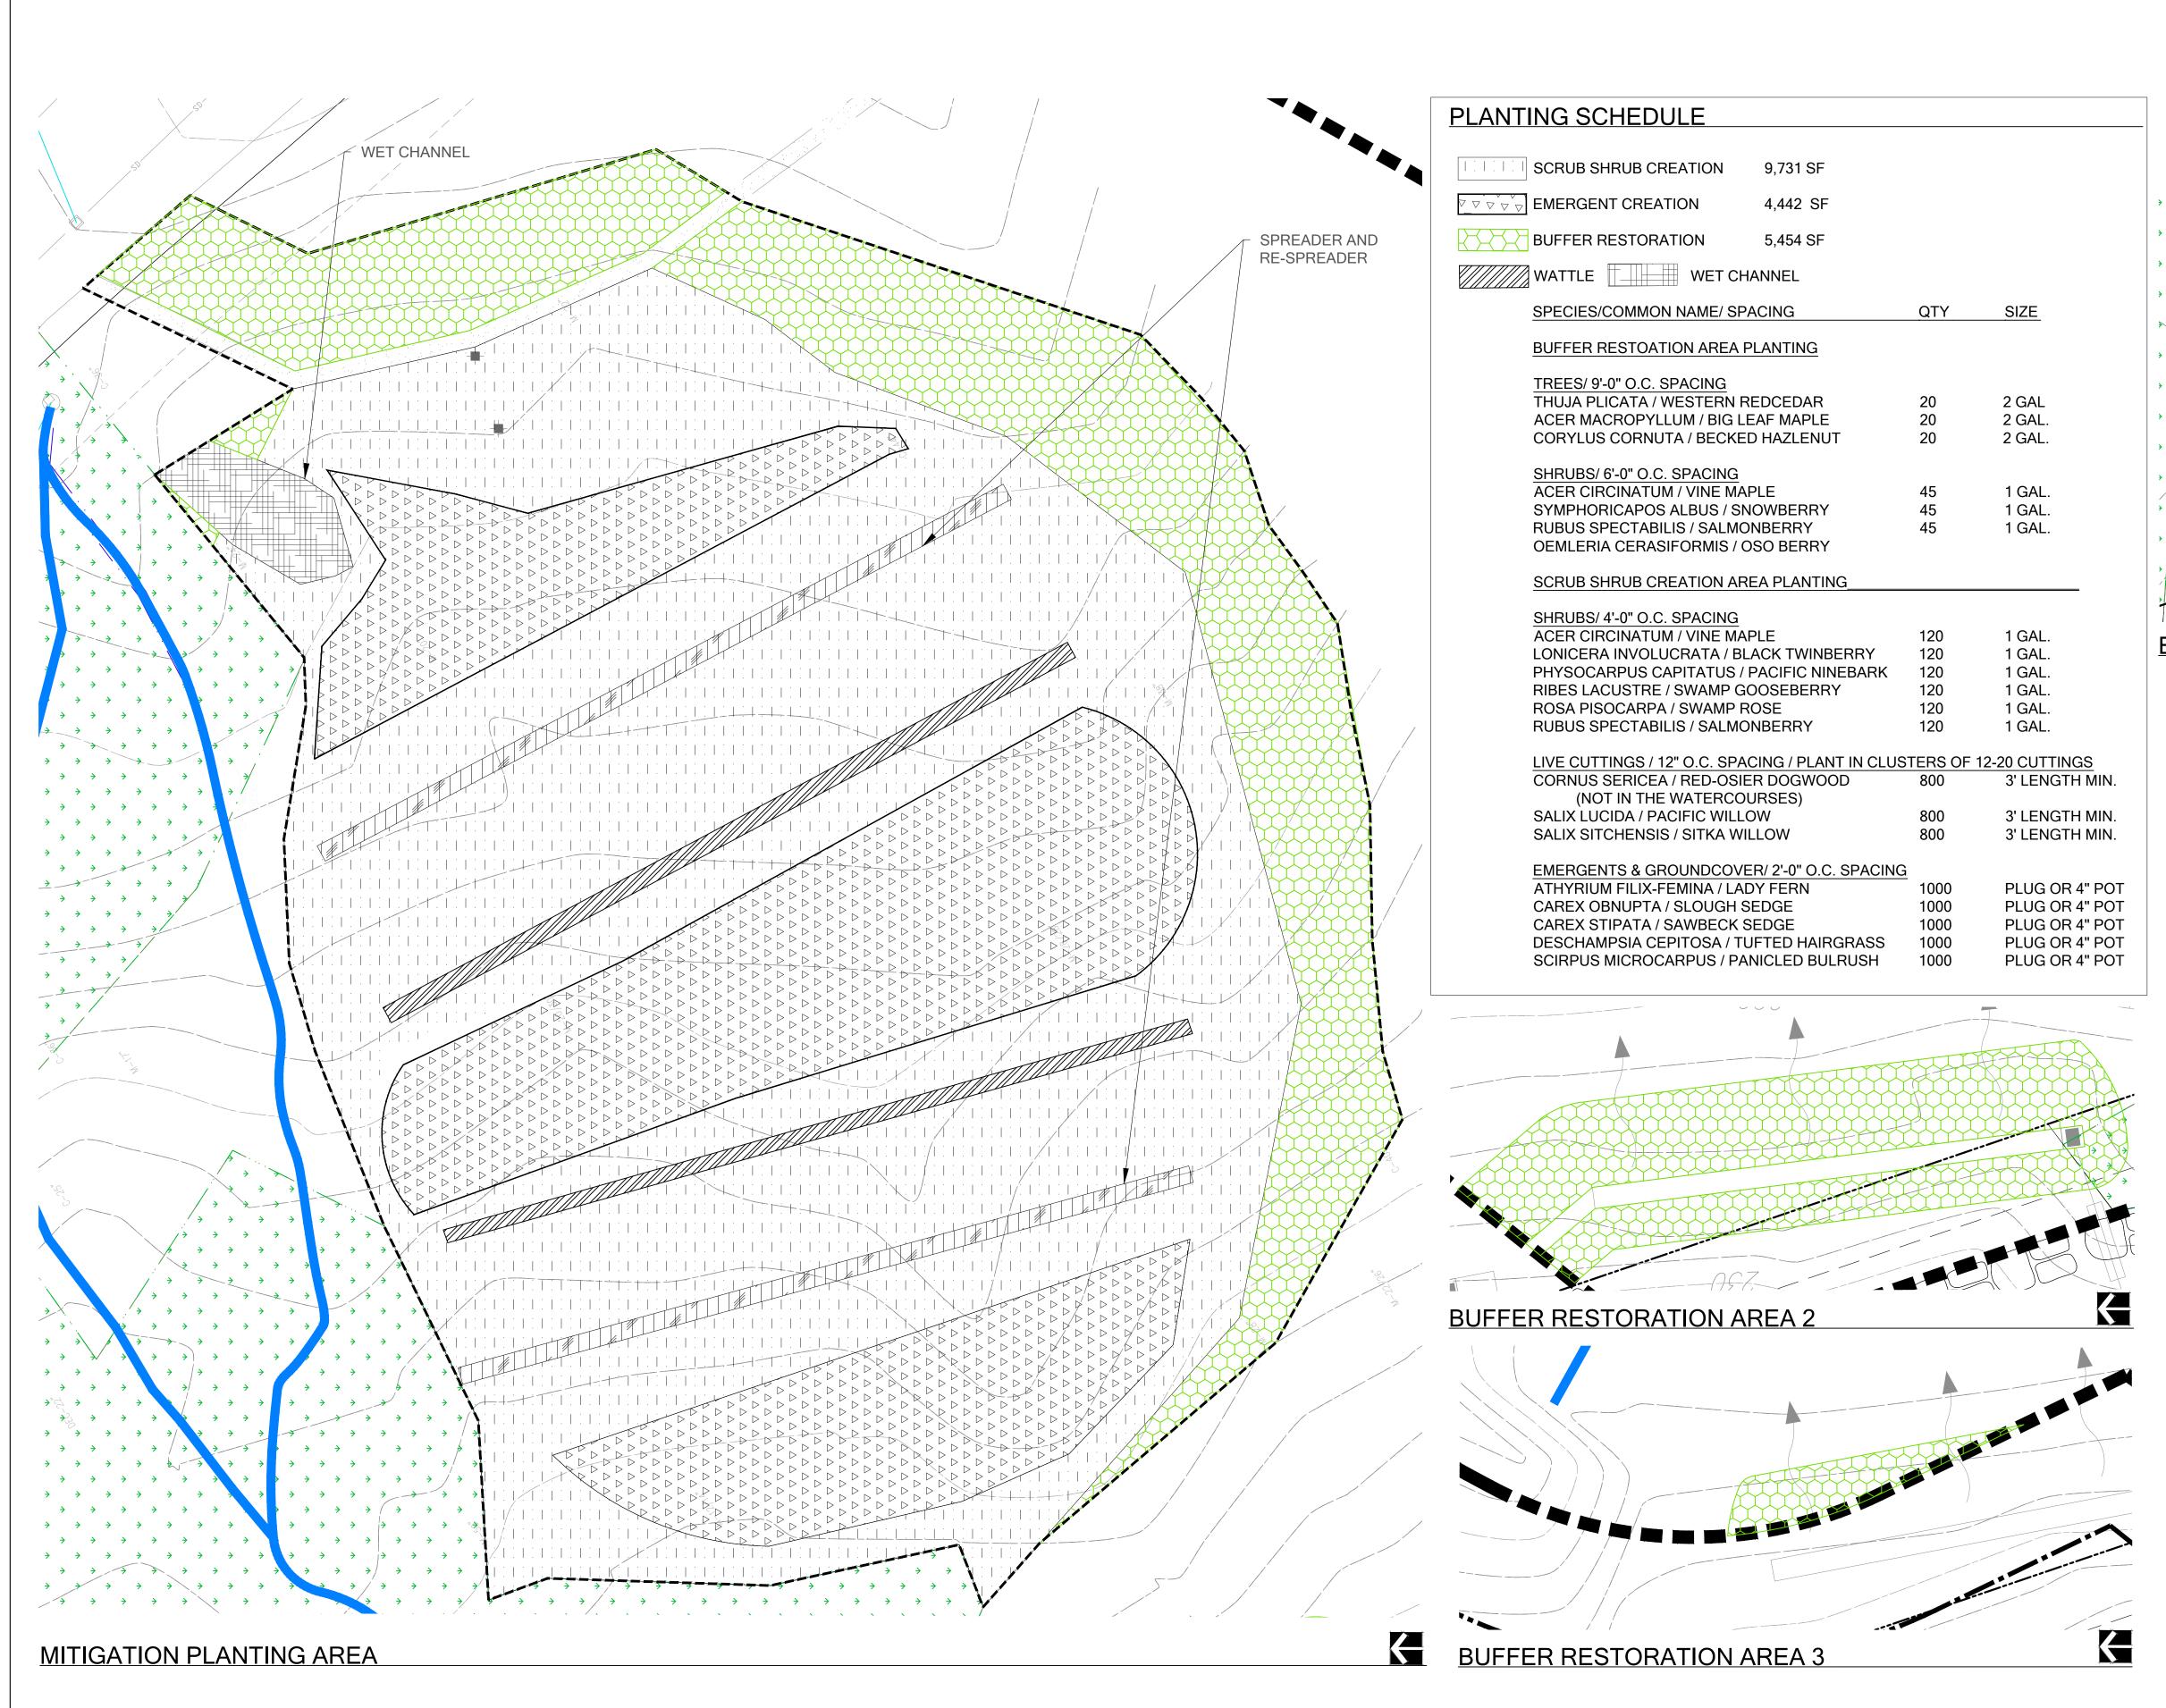

KELKARI TOWNHOMES
SUNRISE PL. S.W.

# IS PROPERTY INVESTMENTS LLC

PROJECT NUMBER: 15-0357
PROJECT MANAGER: JG
DRAWN BY: KMB
PLOT DATE: 2-12-16

SDP/ MSP/ BSP MINOR AMENDMENT APPLICATION 2-12-16

REVISIONS:
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SHEET SIZE 24X36

MITIGATION PLAN

W6 OF 8

### **EXECUTIVE SUMMARY**

THIS PLAN SEEKS TO CREATE NEW WETLAND AND RESTORE TEMPORARY WETLAND BUFFER IMPACTS. THE MITIGATION SERVES AS COMPENSATORY MITIGATION FOR IMPACTS ASSOCIATED WITH A MULTI-FAMILY RESIDENTIAL DEVELOPMENT IN ISSAQUAH.

THE PROPOSED DEVELOPMENT WILL RESULT IN THE PERMANENT WETLAND IMPACTS (FILL), WETLAND PAPER FILL IMPACTS, AND TEMPORARY WETLAND BUFFER IMPACTS. THE PERMANENT WETLAND IMPACTS WILL BE MITIGATED THROUGH WETLAND CREATION AT A 2:1 IMPACT TO CREATION RATIO. IMPACTS ARE PROPOSED IN SCRUB-SHRUB AND EMERGENT WETLAND AREAS, AND APPROPRIATE WETLAND CREATION AREAS WILL BE CREATED IN KIND. WETLAND AREAS PROPOSED FOR "PAPER FILL" ARE NOT ACTUALLY BEING FILLED, BUT RATHER ARE TREATED AS SUCH DUE TO A SIGNIFICANT REDUCTION IN THEIR BUFFERS. THEREFORE, SOME ACTUAL WETLAND AREAS ARE COUNTED ONLY AS BUFFER FOR PURPOSES OF LOCAL PERMITTING. SINCE THESE IMPACTS DO NOT REPRESENT ACTUAL LOSS OF WETLAND AREA, THEY WILL BE MITIGATED THROUGH WETLAND CREATION AT A 1:1 RATIO. TEMPORARY BUFFER IMPACTS, WHICH ARE ANTICIPATED DUE TO GRADING ACTIVITIES AND CONSTRUCTION ACCESS ASSOCIATED WITH THE CONSTRUCTION OF THE WETLAND CREATION AREAS, WILL BE RESTORED WHERE THEY OCCUR AT A 1:1 RATIO. THE TEMPORARY BUFFER IMPACT AREAS INCLUDE IMPACTS IN THE EXPANDED BUFFERS REFLECTING NEW WETLAND CREATION AREAS AND AREAS DISTURBED DUE TO PLACEMENT OF STORM-WATER LEVEL SPREADERS.

PROPOSED IMPACTS AND MITIGATION ARE PRESENTED IN THE TABLE BELOW:

### GOAL

- 1) CREATE 9,781 SQUARE FEET OF PALUSTRINE SCRUB-SHRUB WETLAND.
- a) RECONTOUR UPLAND AREAS TO CREATE EVEN GRADE AND INTERCEPT AN EXISTING SHALLOW WATER TABLE AND FROM LEVEL SPREADERS CARRYING GROUNDWATER INTERCEPTED FROM BENEATH DEVELOPED AREAS.

b) SUPPLEMENT HYDROLOGY THROUGH THE INSTALLATION OF LEVEL SPREADERS THAT DISCHARGE INTERCEPTED SHALLOW GROUNDWATER FROM UPSLOPE DEVELOPED AREAS.

- c) IMPROVE REVEALED SOILS TO BE SUITABLE FOR NATIVE VEGETATION ESTABLISHMENT.
- d) ESTABLISH DENSE, NATIVE, SCRUB-SHRUB PLANT COMMUNITY.
- e) LIMIT INVASION BY NON-NATIVE WEEDS.
- 2) CREATE 4,442 SQUARE FEET OF PALUSTRINE EMERGENT WETLAND.

a) RECONTOUR UPLAND AREAS TO INTERCEPT AN EXISTING SHALLOW WATER TABLE. EXCAVATE CONCAVE DEPRESSIONS ON THE SLOPE TO CREATE SHALLOW PONDING WHERE THE EMERGENT COMMUNITIES WILL ESTABLISH

b) SUPPLEMENT HYDROLOGY THROUGH THE INSTALLATION OF LEVEL SPREADERS THAT DISCHARGE INTERCEPTED SHALLOW GROUNDWATER FROM UPSLOPE DEVELOPED AREAS.

- c) IMPROVE REVEALED SOILS TO BE SUITABLE FOR NATIVE VEGETATION ESTABLISHMENT.
- d) ESTABLISH DENSE, NATIVE, EMERGENT PLANT COMMUNITY.
- e) LIMIT INVASION BY NON-NATIVE WEEDS.
- 3) RESTORE FUNCTIONS IN 5,454 SQUARE FEET OF TEMPORARILY DISTURBED WETLAND BUFFER.
- a) REMOVE AND CONTROL INVASIVE WEEDS.
- b) PRESERVE EXISTING NATIVE VEGETATION WHERE POSSIBLE.
- c) ESTABLISH NATIVE TREE AND SHRUB VEGETATION CLASSES IN TEMPORARILY DISTURBED AREAS.

### PERFORMANCE STANDARDS

THE STANDARDS LISTED BELOW WILL BE USED TO JUDGE THE SUCCESS OF THE PLAN OVER TIME. IF THE STANDARDS ARE MET AT THE END OF THE FIVE-YEAR MONITORING PERIOD, THE MITIGATION SITE WILL BE CONSIDERED SUCCESSFUL AND THE PROJECT WILL HAVE MET ALL CRITICAL AREA PERMITTING OBLIGATIONS.

PS 1) CREATE 9,781 SQUARE FEET OF PALUSTRINE SCRUB SHRUB WETLAND, AND 4,442 SQUARE FEET OF PALUSTRINE EMERGENT WETLAND.

a) ESTABLISH WETLAND HYDROLOGY PER DELINEATION MANUAL DEFINITIONS THROUGHOUT THE WETLAND CREATION AREAS. HYDROLOGY TO BE MEASURED BY SHALLOW GROUNDWATER WELLS AS DESCRIBED IN THE MONITORING PLAN SECTION OF THIS PLAN SET.

- b) ESTABLISH HYDROPHYTIC VEGETATION PER DELINEATION MANUAL DEFINITIONS: (FAC, FACW OR OBL).
- ESTABLISH GREATER THAN 30% COVER OF EACH TARGET VEGETATION CLASS (PSS AND PEM).
- HYDRIC SOILS ARE ASSUMED TO ESTABLISH PROVIDED THE HYDROLOGY STANDARD IS MET.
- PS 2) SURVIVAL/DIVERSITY ACROSS ALL PLANTED MITIGATION AREAS:

a) 100% SURVIVAL OF ALL WOODY PLANTINGS AT THE END OF YEAR ONE. THIS STANDARD MAY BE MET THROUGH ESTABLISHMENT OF INSTALLED PLANTS OR BY REPLANTING AS NECESSARY TO ACHIEVE THE REQUIRED NUMBERS. AREAS PLANTED ENTIRELY WITH LIVE CUTTINGS SHALL NOT BE HELD TO THE 100% SURVIVAL STANDARD. ANY SUCH AREAS THAT EXHIBIT WIDESPREAD MORTALITY SHALL BE RE-EVALUATED BY THE RESTORATION SPECIALIST TO ASCERTAIN THE SITE-SPECIFIC VIABILITY OF THE CUTTINGS.

b) 80% SURVIVAL OF ALL WOODY PLANTINGS AT THE END OF YEAR TWO. THIS STANDARD MAY BE MET THROUGH ESTABLISHMENT OF INSTALLED PLANTS OR BY REPLANTING AS NECESSARY TO ACHIEVE THE REQUIRED NUMBERS. SURVIVAL BEYOND YEAR TWO IS DIFFICULT TO TRACK. THEREFORE, A DIVERSITY STANDARD IS PROPOSED IN PLACE OF SURVIVAL (BELOW). AREAS PLANTED ENTIRELY WITH LIVE CUTTINGS SHALL NOT BE HELD TO THE 80% SURVIVAL STANDARD ANY SUCH AREAS THAT EXHIBIT WIDESPREAD MORTALITY SHALL BE RE-EVALUATED BY THE RESTORATION SPECIALIST TO ASCERTAIN THE SITE-SPECIFIC VIABILITY OF THE CUTTINGS.

- c) ESTABLISH AT LEAST 6 NATIVE SHRUB SPECIES IN THE SCRUB-SHRUB WETLAND.
- d) ESTABLISH AT LEAST 3 NATIVE EMERGENT SPECIES IN THE EMERGENT WETLAND.
- e) ESTABLISH AT LEAST 2 NATIVE TREE SPECIES AND 4 NATIVE SHRUB SPECIES IN THE RESTORED BUFFER AREA.

PS 3) NATIVE WOODY VEGETATION COVER IN THE CREATED SCRUB-SHRUB WETLAND AND WETLAND BUFFER RESTORATION AREA:

a) ACHIEVE AT LEAST 60% COVER OF NATIVE WOODY SPECIES IN PLANTED SCRUB-SHRUB WETLAND AREAS AND RESTORED BUFFER AREAS BY THE END OF YEAR 3. VOLUNTEER SPECIES MAY COUNT TOWARDS THIS STANDARD.

b) ACHIEVE AT LEAST 80% COVER OF NATIVE WOODY SPECIES IN PLANTED SCRUB-SHRUB WETLAND AREAS AND RESTORED BUFFER AREAS BY THE END OF YEAR 5. VOLUNTEER SPECIES MAY COUNT TOWARDS THIS STANDARD.

RESTORED BUFFER AREAS BY THE END OF YEAR 5. VOLUNTEER SPECIES MAY COUNT TOWARDS THIS STANDA

PS 4) NATIVE EMERGENT COVER IN THE CREATED EMERGENT WETLAND AREA:

a) ACHIEVE AT LEAST 50% COVER OF NATIVE EMERGENT SPECIES BY YEAR 3.

- b) ACHIEVE AT LEAST 80% COVER OF NATIVE EMERGENT SPECIES BY YEAR 5.
- c) LEVEL SPREADERS SHALL BE INSTALLED TO AVOID POINT DISCHARGE OF WATER, WHICH COULD RESULT IN CHANNELIZATION BELOW SPREADERS.
- PS 5) INVASIVE SPECIES STANDARDS:
- a) NO MORE THAN 15% COVER OF INVASIVE SPECIES IN ANY OF THE PLANTING AREAS, IN ANY MONITORING YEAR. MORE THAN 10% COVER OF INVASIVE WEEDS IN ANY YEAR WILL TRIGGER MAINTENANCE WEEDING.

### CONTINGENCY PLANS AND ADAPTIVE MANAGEMENT

THESE PLANS HAVE BEEN PREPARED TO ENSURE SUCCESS TO THE MAXIMUM PRACTICABLE EXTENT. HOWEVER, HABITAT CREATION AND ENHANCEMENT IS INHERENTLY UNPREDICTABLE. QUALITY AND CONSISTENCY OF INSTALLATION, MAINTENANCE, WEATHER PATTERN EXTREMES, WILDLIFE DAMAGE, VANDALISM AND OTHER FACTORS CAN SINGLY OR IN COMBINATION CHANGE CONDITIONS AT MITIGATION SITES AND AFFECT EVENTUAL SUCCESS OF THESE PLANS. THEREFORE, ADAPTIVE MANAGEMENT SHOULD BE EMPLOYED TO EVALUATE PROBLEMS AS THEY ARISE AND DEVELOP FLEXIBLE AND PRACTICAL SOLUTIONS. EXAMPLES CAN INCLUDE BUT ARE NOT LIMITED TO PLANT SUBSTITUTION, CHANGES IN TARGET VEGETATION CLASSES, SOIL AMENDMENT, RE-GRADING. AS A LAST RESORT, MODIFICATION OF PERFORMANCE STANDARDS CAN BE NECESSARY. ANY ACTIONS INVOLVING MAJOR DEPARTURES FROM THE ORIGINAL PLAN OR GOALS AND PERFORMANCE STANDARDS SHOULD BE DISCUSSED AND AGREED TO WITH REGULATORY AGENCIES AHEAD OF IMPLEMENTATION.

### AS-BUILT PLAN

AN AS-BUILT PLAN WILL BE PREPARED WITHIN 30 DAYS OF SUBSTANTIALLY COMPLETE CONSTRUCTION OF THE MITIGATION AREA. THE AS-BUILT PLAN WILL DOCUMENT SUBSTANTIAL CONFORMANCE WITH THESE PLANS AND ALSO WILL DISCLOSE ANY SUBSTITUTIONS OR OTHER NON-CRITICAL DEPARTURES. THE AS-BUILT PLAN WILL ESTABLISH TRANSECTS, BASELINE PLANT INSTALLATION QUANTITIES (BASED ON SAMPLE COUNTS OR INVOICES), HYDROLOGY MONITORING WELLS, AND PHOTO POINTS THAT WILL BE USED THROUGHOUT THE MONITORING PERIOD TO MEASURE THE PERFORMANCE STANDARDS OVER TIME.

THE AS-BUILT DOCUMENTATION SHOULD INCLUDE A MARKUP OF THE ORIGINAL PLAN NOTING ANY DEPARTURES, PLUS THE LOCATIONS OF TRANSECTS, WELLS AND PHOTO POINTS.

### MONITORING METHODS

THIS MONITORING PROGRAM IS DESIGNED TO TRACK THE SUCCESS OF THE MITIGATION SITE OVER TIME BY MEASURING THE DEGREE TO WHICH THE PERFORMANCE STANDARDS LISTED ABOVE ARE BEING MET.

### TRANSECT

DURING THE AS-BUILT INSPECTION, THE RESTORATION SPECIALIST SHALL INSTALL BASELINE MONITORING TRANSECTS. A MINIMUM OF TWO 50-FOOT-LONG TRANSECTS SHALL BE LOCATED IN ETHE CREATED SCRUB SHRUB WETLAND AND WETLAND BUFFER RESTORATION AREAS. DURING EACH MONITORING EVENT PERCENT COVER VALUES WILL BE MEASURED ALONG THE TRANSECTS USING THE LINE-INTERCEPT METHOD. A MINIMUM OF TWO FIVE-FOOT-RADIUS MONITORING PLOTS SHALL BE LOCATED IN EACH EMERGENT WETLAND CREATION AREA (SIX TOTAL). DURING EACH MONITORING EVENT, PERCENT COVER OF EMERGENT PLANT COMMUNITY SHALL BE ESTIMATED AT EACH MONITORING PLOT ACCORDING TO THE COVER CLASS METHOD. AREAS OUTSIDE THE ESTABLISHED TRANSECTS WILL BE VISUALLY MONITORED TO VERIFY THAT PERFORMANCE STANDARDS ARE

BEING MET.
PHOTOPOINTS SHALL BE ESTABLISHED AT EITHER END OF ALL TRANSECTS AND AT OTHER REPRESENTATIVE LOCATIONS AS

# DETERMINED BY THE RESTORATION SPECIALIST. HYDROLOGY WELLS

AT LEAST 8 SHALLOW GROUNDWATER WELLS SHALL BE INSTALLED DURING THE AS-BUILT CONDITION. WELLS SHALL BE CONSTRUCTED OF 24-INCH LENGTHS OF 2-INCH DIAMETER PVC PIPE. THE LOWER 18 INCHES SHALL BE PERFORATED BY DRILLING A SERIES OF 1/4-INCH HOLES. WELLS WILL BE INSTALLED TO A DEPTH OF 18 INCHES. EACH WELL SHALL BE FITTED WITH A PIPE END FITTING CAP.

HYDROLOGY WELLS SHALL BE MONITORED WEEKLY (TOTAL OF 6 TIMES PER YEAR) FROM MARCH 1ST THROUGH APRIL 15TH OF THE FIRST TWO YEARS FOLLOWING ACCEPTANCE OF THE AS-BUILT CONDITION. WELLS WILL ALSO BE MONITORED DURING THE SUMMER VEGETATION ASSESSMENT MONITORING VISIT.

OUTSIDE OF HYDROLOGY WELL MONITORING, OTHER PERFORMANCE MONITORING SHALL OCCUR TWICE ANNUALLY FOR FIVE YEARS. A SPRING MONITORING VISIT SHALL RECORD NECESSARY REPLANTING, WEEDING, INVASIVE CONTROL, AND OTHER MAINTENANCE NEEDS. THE RESTORATION SPECIALIST WILL THEN NOTIFY THE OWNER AND/OR MAINTENANCE CREWS OF NECESSARY EARLY SEASON MAINTENANCE. THE SECOND VISIT SHALL OCCUR IN LATE SUMMER OR FALL AND CONTAIN THE BULK OF THE MONITORING WORK. THE ANNUAL MONITORING REPORT WILL RELATE THE FOLLOWING INFORMATION:

- 1) GENERAL SUMMARY OF THE SPRING VISIT.
- 2) HYDROLOGY MEASUREMENT RESULTS.
- 3) FIRST- AND SECOND-YEAR COUNTS OF SURVIVING AND DEAD/DYING WOODY PLANTS BY SPECIES IN THE SCRUB-SHRUB
- WETLAND CREATION AREA AND THE WETLAND BUFFER RESTORATION AREAS.
- 4) ESTIMATES OF NATIVE WOODY SPECIES COVER ALONG MONITORING USING THE LINE INTERCEPT METHOD IN THE SCRUB-SHRUB WETLAND CREATION AREA AND THE WETLAND BUFFER RESTORATION AREAS.
- 5) ESTIMATES OF INVASIVE SPECIES COVER ALONG RANDOM SUB-TRANSECTS USING THE LINE INTERCEPT METHOD.
- 6) ESTIMATES OF NATIVE EMERGENT SPECIES COVER USING THE COVER CLASS METHOD IN THE PALUSTRINE EMERGENT WETLAND CREATION AREA.
- 7) COUNTS OF ESTABLISHED NATIVE SPECIES TO DETERMINE SITE DIVERSITY, BY MITIGATION AREA TYPE OR PLANTING ZONE.
- 8) NOTES AND/OR SKETCHES OF INVASIVE WEEDS OR BARE AREAS OUTSIDE OF TRANSECTS AND PLOTS.
- 9) PHOTOGRAPHIC DOCUMENTATION FROM TRANSECTS ENDS AND ESTABLISHED REFERENCE POINTS.
- 10) INTRUSIONS INTO THE PLANTING AREAS, VANDALISM, TRASH, AND OTHER ACTIONS DETRIMENTAL TO THE OVERALL HEALTH OF THE MITIGATION AREA.
- 11) RECOMMENDATIONS FOR MAINTENANCE IN THE MITIGATION AREA.

### CONSTRUCTION NOTES AND SPECIFICATIONS

### WORK SEQUENCE

NOTE: SPECIFICATIONS FOR ITEMS IN BOLD CAN BE FOUND UNDER "MATERIAL SPECIFICATIONS AND DEFINITIONS."

THE WATERSHED COMPANY PERSONNEL, OR OTHER PERSONS QUALIFIED TO EVALUATE ENVIRONMENTAL RESTORATION

PROJECTS, SHALL MONITOR:

- CLEARING AND GRADE STAKING.
   POUGH AND FINAL GRADING INCL.
- 2) ROUGH AND FINAL GRADING INCLUDING EXCAVATION AND SPOIL PLACEMENT.
- 3) SOIL DE-COMPACTION, AMENDMENT AND/OR IMPORTATION.
- 4) PLANT INSPECTIONS:
- a) PLANT DELIVERY INSPECTION.
- 50% PLANT INSTALLATION/LAYOUT INSPECTION.
- 100% PLANT INSTALLATION INSPECTION.

# GENERAL WORK SEQUENCE

### GRADING:

- 1) SURVEY AND STAKE THE LIMITS OF THE WETLAND CREATION AREAS.
- 2) INSTALL TEMPORARY EROSION AND STORM WATER CONTROL BMPS, INCLUDING SILT FENCING AROUND THE PERIMETER OF THE WORK AREA.
- 3) SURVEY AND STAKE CUT DEPTHS FOR ALL WETLAND CREATION DEPRESSIONS. CLEAR TREES AND BRUSH, AS NECESSARY.
- 4) ROUGH GRADE THE WETLAND CREATION AREAS AT THE DIRECTION OF THE RESTORATION SPECIALIST.
- 5) GRADING SPOILS TO BE REMOVED FROM SITE.
- 6) FINALIZE WETLAND AND UPLAND GRADING, AMENDING ALL GRADED AREAS TO MEET THE FOLLOWING CRITERIA:
  - THE CREATED SCRUB-SHRUB WETLAND AND CREATED EMERGENT WETLAND SOILS SHALL BE AMENDED WITH

COMPOST TO ACHIEVE AT LEAST 45% ORGANIC MATERIAL IN THE UPPER 9 INCHES (397 CUBIC YARDS).

- 7) ALL GRADING AREAS AND MACHINERY ROUTES TO BE DE-COMPACTED AS NECESSARY IN PREPARATION FOR PLANTING. DECOMPACTING SHALL BE BY ROTO-TILLER OR SIMILAR METHOD THAT DECONSOLIDATES THE UPPER 9 INCHES OF SOIL.
- 8) INSTALL LEVEL SPREADERS, RE-SPREADERS, AND WATTLES PER PLANS (SHEETS W6 & W8).
- 9) WITHIN ONE WEEK OF GRADING ACCEPTANCE BY THE RESTORATION SPECIALIST, STABILIZE ALL GRADED AND DE-COMPACTED AREAS WITH WOOD CHIP MULCH TO AN AVERAGE DEPTH OF 4 INCHES (122 CUBIC YARDS). EXCEPTIONS: THE EMERGENT WETLAND CREATION AREAS SHALL NOT RECEIVE MULCH.

### PLANTING:

1) ALL PREPARATION AND PLANTING SHALL TAKE PLACE DURING THE DORMANT SEASON (OCTOBER THROUGH APRIL) FOR BEST SURVIVAL, EXCEPT FOR EMERGENT SPECIES. PLANTING OF EMERGENT SPECIES SHALL TAKE PLACE FROM MARCH 1ST THROUGH JUNE 15TH. THE RESTORATION SPECIALIST MAY APPROVE PLANTING OUTSIDE OF THESE TIMES BASED ON FAVORABLE WEATHER CONDITIONS DURING THE PLANTING PERIOD.

2) REMOVE ALL INVASIVE WEEDS AND WEED ROOTS FROM ENTIRE PLANTING AREA AS DIRECTED BY THE RESTORATION SPECIALIST. AVOID DAMAGE TO EXISTING NATIVE VEGETATION.

3) DE-COMPACT SOIL AS NEEDED ACROSS THE ENTIRE PLANTING AREA USING A ROTOTILLER OR SIMILAR METHOD. ALL MACHINERY ROUTES AND ACCESS ROADS THROUGH PLANTED AREAS SHALL BE DECOMPACTED.

- 4) INSTALL VEGETATION PER THE PLANTING PLANS AND PLANTING DETAILS.
- 5) INSTALL BLANKET APPLICATION OF WOOD CHIP MULCH IN THE CREATED SCRUB-SHRUB WETLAND AREAS AND THE WETLAND BUFFER RESTORATION AREAS. SEE PLANTING DETAILS FOR MULCH SPECIFICATIONS.
- 6) THE RESTORATION SPECIALIST SHALL INSPECT: ALL PLANT MATERIAL PRIOR TO INSTALLATION, AT 50% PLANT LAYOUT/INSTALLATION AND AT 100% PLANT INSTALLATION
- 7) DUE TO EXISTING SITE CONDITIONS (RELATIVELY HIGH GROUNDWATER TABLE, OVERHANGING FOREST CANOPY), A TEMPORARY IRRIGATION SYSTEM IS LIKELY NOT REQUIRED. SUPPLEMENTAL IRRIGATION IN TARGETED AREAS MAY BE NECESSARY AT THE DIRECTION OF THE RESTORATION SPECIALIST FROM JUNE 1 THROUGH SEPTEMBER 30.

### MAINTENANCE

THIS SITE WILL BE MAINTAINED FOR FIVE YEARS FOLLOWING COMPLETION OF THE CONSTRUCTION. SPECIFICATIONS IN BOLD CAN BE FOUND UNDER "MATERIAL SPECIFICATIONS AND DEFINITIONS."

- 1) AT LEAST TWICE-YEARLY, HAND REMOVE ALL COMPETING WEEDS AND WEED ROOTS FROM BENEATH EACH INSTALLED PLANT AND ANY DESIRABLE VOLUNTEER VEGETATION TO A DISTANCE OF 18 INCHES FROM THE MAIN PLANT STEM. WEEDING SHOULD OCCUR AS NEEDED DURING THE SPRING AND SUMMER. FREQUENT WEEDING WILL RESULT IN LOWER MORTALITY AND LOWER PLANT REPLACEMENT COSTS OR.
- 2) ALTERNATIVELY, SHOULD HAND WEEDING PROVE UNMANAGEABLE, THE RESTORATION SPECIALIST MAY AUTHORIZE THE LIMITED USE OF AN AQUATIC USE-APPROVED HERBICIDE TO CONTROL COMPETITIVE WEEDS AT THE BASE OF INSTALLED VEGETATION. ONLY INDIVIDUALS WHO ARE STATE-LICENSED HERBICIDE APPLICATORS MAY CONDUCT HERBICIDE TREATMENTS. APPLICATIONS SHOULD BE DONE BETWEEN MID-SPRING AND MID-SUMMER TO MAXIMIZE UPTAKE BY PLANTS.
- 3) DO NOT WEED THE AREA NEAR THE PLANT BASES WITH STRING TRIMMER (WEED WHACKER). NATIVE PLANTS ARE EASILY DAMAGED OR KILLED, AND WEEDS EASILY RECOVER AFTER TRIMMING.

4) APPLY SLOW RELEASE GRANULAR FERTILIZER TO EACH INSTALLED WOODY PLANT ANNUALLY IN THE SPRING (BY JUNE 1) OF YEARS TWO THROUGH FIVE BUT <u>NOT</u> IN YEAR ONE.

5) MULCH THE WEEDED AREAS BENEATH EACH WOODY PLANT WITH WOOD CHIP MULCH AS NECESSARY TO MAINTAIN A

MINIMUM FOUR-INCH THICK, 18-INCH DIAMETER MULCH RING.

6) PROVIDE SUPPLEMENTAL IRRIGATION IN TARGETED AREAS USING A WATERING TRUCK, BACKPACKS, OR SIMILAR METHOD AT THE DISCRETION OF THE RESTORATION SPECIALIST.

7) FOLLOW THE RECOMMENDATIONS NOTED IN THE SPRING MONITORING SITE VISIT.

- 8) ALL PLANT REPLACEMENT SHALL TAKE PLACE DURING THE FOLLOWING TIMES FOR BEST SURVIVAL:
- a) ONE- AND TWO-GALLON CONTAINER PLANTS MAY BE INSTALLED BETWEEN OCTOBER 1ST AND MARCH 31ST.
- b) EMERGENT PLUGS MAY BE INSTALLED BETWEEN MARCH AND JULY 1ST.
- c) LIVE STAKES (CUTTINGS) MAY BE INSTALLED BETWEEN OCTOBER 1ST AND MARCH 31ST.
   d) THE RESTORATION SPECIALIST MAY APPROVE PLANTING OUTSIDE OF THE ABOVE TIMES ON A CASE-BY-CASE BASIS
- DEPENDING ON THE LOCATION, EXTENT AND SPECIFIC SEASONAL CONDITIONS.
- 9) INVASIVE SPECIES MAINTENANCE PLAN:

a) HIMALAYAN/EVERGREEN BLACKBERRY, SCOTCH BROOM AND OTHER INVASIVE WOODY VEGETATION SHALL BE GRUBBED OUT BY HAND ON AN ONGOING BASIS, BEING CAREFUL TO GRUB OUT ROOTS EXCEPT WHERE SUCH WORK WILL JEOPARDIZE THE ROOTS OF INSTALLED NATIVE OR VOLUNTEER NATIVE PLANTS.

b) REED CANARYGRASS CAN BE PULLED BY HAND IF FOUND AS INDIVIDUAL STALKS OR SMALL CLUMPS. LARGER CLUMPS MAY REQUIRE USE OF AN HERBICIDE APPROVED FOR USE IN AQUATIC AREAS USING A TARGETED METHOD, SUCH AS SPOT SPRAY. ONLY INDIVIDUALS WHO ARE STATE-LICENSED HERBICIDE APPLICATORS MUST CONDUCT HERBICIDE TREATMENTS. APPLICATIONS SHOULD BE DONE BETWEEN MID-SPRING AND LATE-SUMMER TO MAXIMIZE UPTAKE BY PLANTS.

c) ONCE PER YEAR, VINES AND THICKETS ENCROACHING FROM OUTSIDE OF THE PLANTED AREA ARE TO BE CUT BACK TO AT LEAST TEN FEET FROM THE PLANTED AREA.

# MATERIAL SPECIFICATIONS AND DEFINITIONS

**ENVIRONMENTAL RESTORATION PROJECTS.** 

1) WOOD CHIP MULCH: COARSE WOODCHIP MULCH APPROXIMATELY ONE TO THREE INCHES IN MAXIMUM DIMENSION (NOT SAWDUST OR COARSE HOG FUEL). THIS MATERIAL IS SOLD AS "ANIMAL FRIENDLY HOG FUEL" AT PACIFIC TOPSOILS [(800) 884-7645]. MULCH SHALL NOT CONTAIN APPRECIABLE QUANTITIES OF GARBAGE, PLASTIC, METAL, SOIL, AND DIMENSIONAL LUMBER OR CONSTRUCTION/DEMOLITION DEBRIS. QUANTITY REQUIRED: 122 CUBIC YARDS.

2) FERTILIZER: SLOW RELEASE, GRANULAR FERTILIZER SUCH AS OSMOCOTE™ OR EQUAL PRODUCT. MOST RETAIL NURSERIES CARRY THIS PRODUCT. FOLLOW MANUFACTURER'S INSTRUCTIONS FOR APPLICATION. KEEP FERTILIZER IN A WEATHER-TIGHT CONTAINER WHILE ON SITE. NOTE THAT FERTILIZER IS TO BE APPLIED ONLY IN YEARS TWO, THREE, FOUR AND FIVE AND NOT IN THE FIRST YEAR. FERTILIZER SHALL NOT BE PLACED IN INUNDATED AREAS.

3) COMPOST: CEDAR GROVE COMPOST OR EQUIVALENT PRODUCT. 100% VEGETABLE COMPOST WITH NO APPRECIABLE QUANTITIES OF SAND, GRAVEL, SAWDUST, OR OTHER NON-ORGANIC MATERIALS. AMENDMENT QUANTITY REQUIRED FOR CONSTRUCTION: 397 CUBIC YARDS.

4) RESTORATION SPECIALIST: THE WATERSHED COMPANY PERSONNEL OR OTHER PERSONS QUALIFIED TO EVALUATE

# IS PROPERTY INVESTMENTS LLC

PROJECT NUMBER: 15-035
PROJECT MANAGER: J
DRAWN BY: KM
PLOT DATE: 2-12

SDP/ MSP/ BSP MINOR AMENDMENT APPLICATION 2-12-16

FEBRUARY 12, 2016 SDP/ MSP/ BSP MINOR

**APPLICATION** 

REVISIONS

THE

750 Sixth Street South Kirkland WA 98033


p 425.822.5242 f 425.827.8136 www.watershedco.com

SHEET SIZE 24X36

Science & Design

MITIGATION PLAN

W7 OF 8

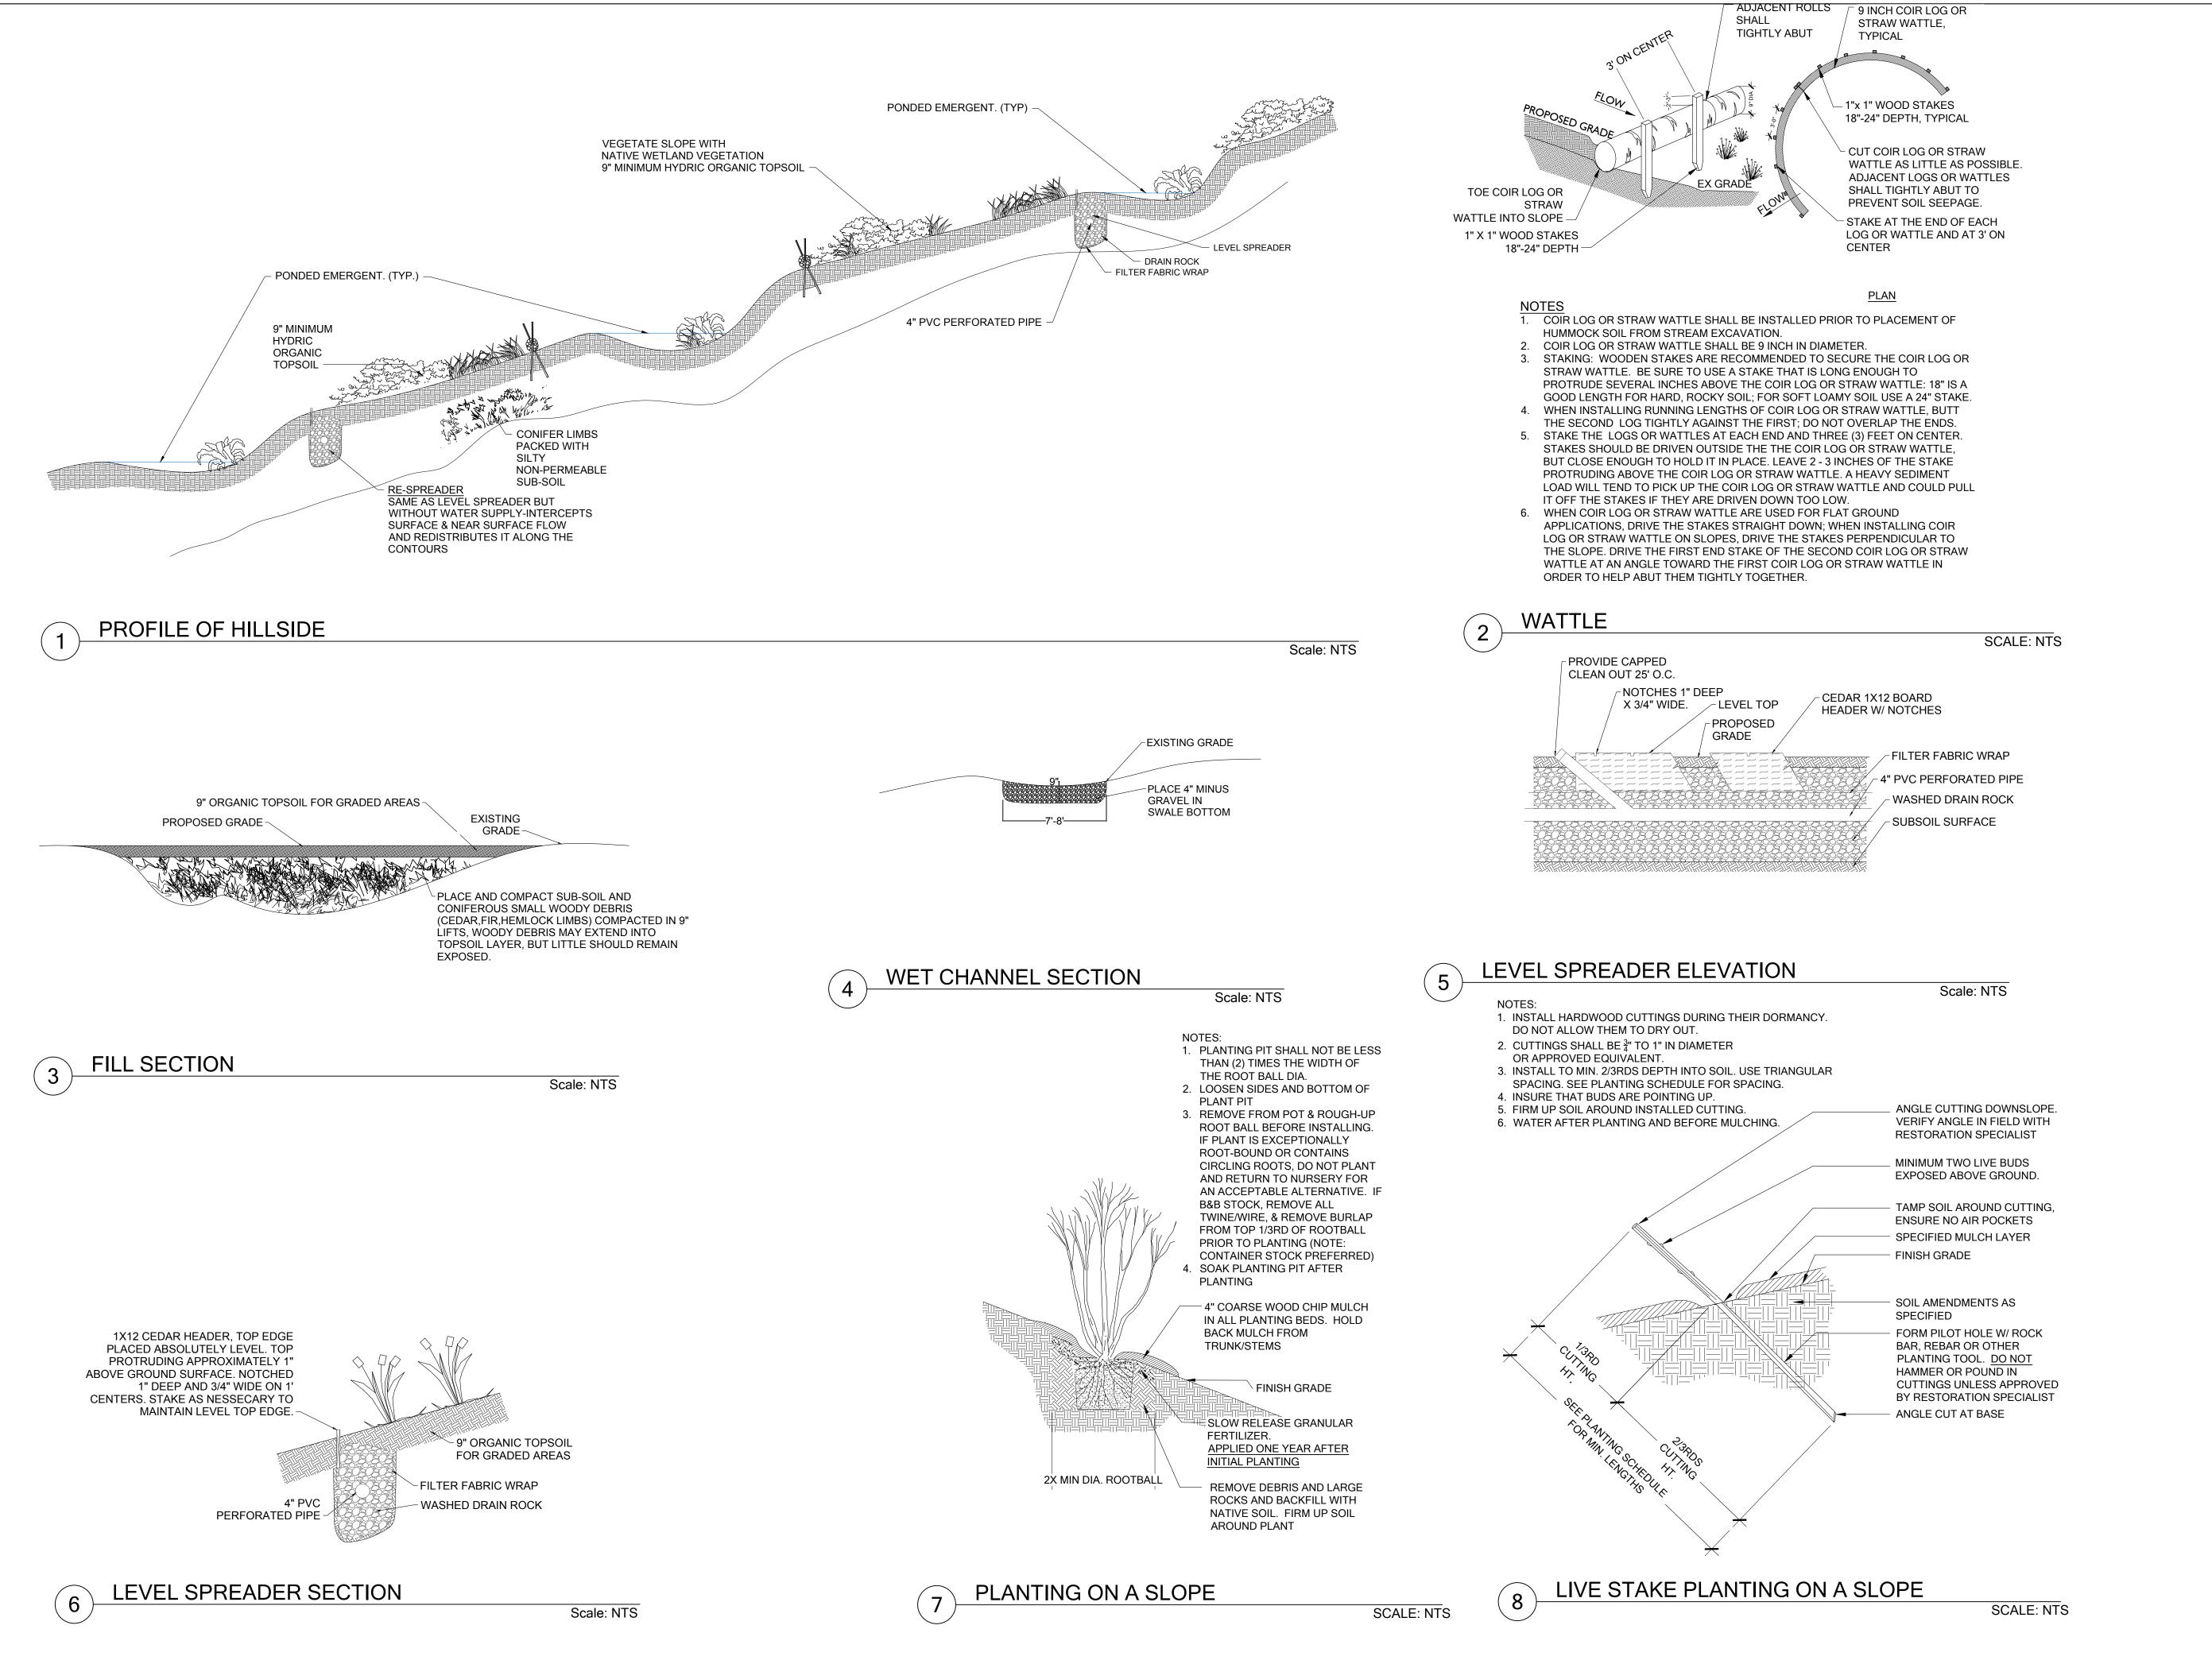

SUNRISE PL. S.W.

IS PROPERTY
INVESTMENTS LLC

PROJECT NUMBER: 15-0357
PROJECT MANAGER: JG
DRAWN BY: KMB
PLOT DATE: 2-12-10

SDP/ MSP/ BSP MINOR AMENDMENT APPLICATION 2-12-16

REVISIONS:

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Science & Design

SHEET SIZE 24X36

MITIGATION PLAN

W8 OF 8



LANDSCAPE CONSULTANT

INVESTMENTS

PROJECT MANAGER:

SDP/ MSP/ BSP MINOR AMENDMENT APPLICATION 2-12-16

SDP/ MSP/ BSP MINOR AMENDMENT APPLICATION

NORTH SITE LANDSCAPE PLAN

SOUTH SITE LANDSCAPE PLAN



WEISMAN**DESIGN**GROUP

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PICNICKING ARE

PICNICKING AREA

TRAIL

KELKARI TOWNHOMES SUNRISE PL. S.W. ISSAQUAH, WASHINGTON

S PROPERTY NVESTMENTS II.C.

OJECT NUMBER:
OJECT MANAGER:
AWN BY:

SDP/ MSP/ BSP MINOR AMENDMENT APPLICATION 2-12-16

ISIONS:

FEBRUARY 12, 2016

SDP/ MSP/ BSP

MINOR AMENDMENT

APPLICATION

ENLARGED VIEW — AMENITY SPACES

\_102



AMENDMENT APPLICATION 2-12-16

FEBRUARY 12, 2016 SDP/ MSP/ BSP MINOR AMENDMENT APPLICATION

ENLARGED VIEW — AMENITY SPACES

### PRELIMINARY LANDSCAPE SCHEDULE

SYMBOLS SHOWN AT 20 SCALE

SYMBOL	BOTANICAL/COMMON NAME	SIZE/CONDITION/REMARKS
	DECIDUOUS TREES	
	ACER SACCHARUM 'LEGACY' LEGACY SUGAR MAPLE	2" CALIPER, 10—12" HT. , WELL— BRANCHED ABOVE 6" HT., MATCHED, B&B.
3	ACER MACROPHYLLUM BIG LEAF MAPLE	2" CALIPER, 10-12" HT. , WELL- BRANCHED ABOVE 6" HT., MATCHED, B&B.
	BETULA PAPYRIFERA PAPER BIRCH	2" CALIPER SINGLE STEMMED OR (3) 1/2" CAL. MULTI—STEMMED, 8'—10' HT., WELL—BRANCHED, FULL BUSHY, B&B.
	ACER CIRCINATUM VINE MAPLE	MULTI-STEMMED, MIN (3) 1/2" CALIPER TRUNKS, 8'-10" HT., WELL-BRANCHED, FULL & BUSHY, B&B.
$\left(\cdot\right)^{-1}$	AMELANCHIER 'AUTUMN BRILLIANCE' AUTUMN BRILLIANCE SERVICEBERRY	MIN 1-1/2" CALIPER, 8'-10' HT., WELL-BRANCHED, FULL & BUSHY, B&B
	MAGNOLIA X SOULANGEANA SAUCER MAGNOLIA	MIN 1-1/2" CALIPER, 8'-10' HT., WELL-BRANCHED, FULL & BUSHY, B&B
	CORNUS NUTTALLII PACIFIC DOGWOOD	MIN 1-1/2" CALIPER, 8'-10' HT., WELL-BRANCHED, FULL & BUSHY, B&B
	HAMAMELIS X INTERMEDIA 'JELENA' JELENA WITCH HAZEL	MULTI-STEMMED, MIN $(3)$ , $4'-6'$ HT., FULL & BUSHY TO BASE,
_	EVERGREEN TREES	
	THUJA PLICATA WESTERN RED CEDAR	8'-10' HT., FULL & BUSHY TO BASE, B&B
+ Harry	PSEUDOTSUGA MENZIESII DOUGLAS FIR	8'-10' HT., FULL & BUSHY TO BASE, B&B
my	LARGE SHRUBS	
<b>(</b>	HOLODISCUS DISCOLOR OCEANSPRAY	24-30" HT. & SPR., FULL & BUSHY, B&B OR CON
$\bigcirc$	MAHONIA AQUIFOLIUM OREGON GRAPE HOLLY	
+	MYRICA CALIFORNICA PACIFIC WAX MYRTLE	
	PHILADELPHUS LEWISII MOCK ORANGE	
$\bigotimes$	RIBES SANGUINEA RED—FLOWERING CURRANT	•
	VINES	
_	CLEMATIS ARMANDII EVERGREEN CLEMATIS	1 GAL. POTS, FULL & BUSHY, B&B, CONT.
<u>.W.</u>	LONICERA CILIOSA ORANGE HONEYSUCKLE	1 GAL. POTS, FULL & BUSHY, B&B, CONT.

## PLANTING NOTES

PLANTED 18" O.C.

- 1. INSTALL 3" DEPTH SPECIFIED MULCH IN ALL NEW LANDSCAPE AREAS.
- 2. INSTALL 8" DEPTH SPECIFIED TOPSOIL IN ALL SHRUB AREAS.
- 3. INSTALL 8" DEPTH SPECIFIED TOPSOIL IN ALL LAWN AREAS. 4. ALL LANDSCAPE AREAS WILL BE WATERED WITH AN AUTOMATIC, WATER CONSERVING
- IRRIGATION SYSTEM.
  5. REFER TO CIVIL DEMOLITION DRAWINGS AND SPECIFICATIONS FOR REMOVAL REQUIREMENTS
- OF EXISTING VEGETATION.

  6. REFER TO CIVIL PLANS FOR NEW UTILITY WORK. CONTRACTOR RESPONSIBLE FOR PATCH
- AND REPAIR OF ALL EXISTING LANDSCAPE AREAS DISTURBED BY CONSTRUCTION WORK
- UNDER THIS CONTRACT.
- 7. STREET TREES WILL BE LIMBED UP TO MEET SITE DISTANCE REQUIREMENTS. 8. EXCAVATIONS ADJACENT PRESERVED CEDAR TREE (LOCATED BETWEEN BUILDINGS 12 & 13)
- SHALL BE CONDUCTED WITH THE OBSERVATION OF AN ARBORIST.

  9. EXACT LOCATION OF TRAIL CONNECTION TO BE DETERMINED IN THE FIELD AT TIME OF
- CONSTRUCTION.

  10. TYPICAL ON-GRADE DRIVEWAY PLANTING STRIPS TO INCLUDE 1-2 KELSEY DOGWOOD (UNLESS UNDER 18" WIDE), MIX OF 30% CREEPING MAHONIA, 40% SALAL, 30% SWORD FERN

SYMBOL	BOTANICAL/COMMON NAME	SIZE/CONDITION/REMARKS
	PLANTING MIX #1 - ACCENTS AND PATIOS	
Ø	CORNUS ALBA 'AUREA' RED—STEMMED DOGWOOD	18-24" HT. & SPR., FULL & BUSHY, B&B OR CON
<b>⊕</b>	CORNUS ALBA 'ELEGANTISSIMA' VARIEGATED RED TWIG DOGWOOD	18-24" HT. & SPR., FULL & BUSHY, B&B OR CON
	30% GAULTHERIA SHALLON SALAL	1 GAL. POTS, FULL & BUSHY, B&B, CONT.
	30% MAHONIA NERVOSA DWARF OREGON GRAPE	
ļ	30% POLYSTICHUM MUNITUM SWORD FERN	
	30% DICENTRA FORMOSA PACIFIC BLEEDING HEART	
	30% OXALIS OREGANA REDWOOD SORREL	
<b>,</b>	30% SMILACINA RACEMOSA FALSE SOLOMON'S SEAL	
	PLANTING MIX #2 — FOREST FLOOR	
	CORNUS SERICEA 'KELSEYI'	18-24" HT. & SPR., FULL & BUSHY, B&B OR CONT
	KELSEY DOGWOOD  MAHONIA NERVOSA	18-24" HT. & SPR., FULL & BUSHY, B&B OR CONT
	DWARF OREGON GRAPE POLYSTICHUM MUNITUM	1 GAL. POTS, FULL & BUSHY, B&B, CONT.
ļ	SWORD FERN VACCINIUM OVATUM	
00000000	EVERGREEN HUCKLEBERRY 25% ACHILLEA MILLEFOLIUM YARROW	
	25% ARMERIA MARITIMA	
	SEA THRIFT  25% TELLIMA GRANDIFLORA	
,	FRINGE CUP  25% FRAGERIA CHILOENSIS BEACH STRAWBERRY	
	PLANTING MIX #3 — STEEP SLOPES	
)	ROSA NUTKANA NUTKA ROSE	18-24" HT. & SPR., FULL & BUSHY, B&B OR CONT
)	RUBUS PARVIFLORUS THIMBLEBERRY	
<b>③</b>	SYMPHORICARPOS MOLLIS CREEPING SNOWBERRY	
	25% ACHILLEA MILLEFOLIUM YARROW	1 GAL. POTS, FULL & BUSHY, B&B, CONT.
<u>////</u>   	25% GAULTHERIA SHALLON SALAL	
	25% MAHONIA REPENS CREEPING OREGON GRAPE	
ļ	25% POLYSTICHUM MUNITUM	
	SWORD FERN  PLANTING MIX #4 — STREET/BUFFER ZONES	
	GAULTHERIA SHALLON	18-24" HT. & SPR., FULL & BUSHY, B&B OR CONT
occ D	SALAL ROSA GYMNOCARPA	18-24" HT. & SPR., FULL & BUSHY, B&B OR CONT
XX	BALDHIP ROSE 30% ACHILLEA MILLEFOLIUM	1 GAL. POTS, FULL & BUSHY, B&B, CONT.
	YARROW 30% POLYSTICHUM MUNITUM	
	SWORD FERN 30% TELLIMA GRANDIFLORA	
	FRINGE CUP	

SAVE AND PROTECT, SEE CIVIL

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SUNRISE PL. S.W.

IS PROPERTY
INVESTMENTS
LLC

PROJECT NUMBER: 15-0357
PROJECT MANAGER: JG
DRAWN BY: KR
PLOT DATE: Feb 12, 2016 - 11:58am

SDP/ MSP/ BSP MINOR AMENDMENT APPLICATION 2-12-16

REVISIONS:

FEBRUARY 12, 2016

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MINOR AMENDMENT

APPLICATION

PLANTING SCHEDULE

WEISMAN**DESIGN**GROUP

EXISTING TREES TO REMAIN

LANDSCAPE 2329 E MADISON ST 206-322-1732 CONSULTANT SEATTLE WA 98112 WWW.WDGINC.COM

DESCRIPTION

PROPOSED LANDSCAPE BOLLARD LIGHT TO MATCH EXISTING

WEISMAN**DESIGN**GROUP

0' 15' 30'





EXISTING STREET LIGHT



EXISTING STREET LIGHT



EXISTING BOLLARD LIGHT

# LIGHTING LEGEND

EXISTING STREET LIGHT

PROPOSED INTERNAL STREET LIGHT TO MATCH EXISTING

2329 E MADISON ST 206-322-1732 SEATTLE WA 98112 **WWW.WDGINC.COM** 

L200

LANDSCAPE LIGHTING



KELKARI TOWNHOMES
SUNRISE PL. S.W.

IS PROPERTY INVESTMENTS LLC


PROJECT NUMBER: 15-0
PROJECT MANAGER:

DRAWN BY:
PLOT DATE: Feb 12, 2016 - 2

SDP/ MSP/ BSP MINOR AMENDMENT APPLICATION 2-12-16

EVISIONS: FEBRUARY 12, 2016 SDP/ MSP/ BSP MINOR AMENDMENT APPLICATION

LANDSCAPE LIGHTING

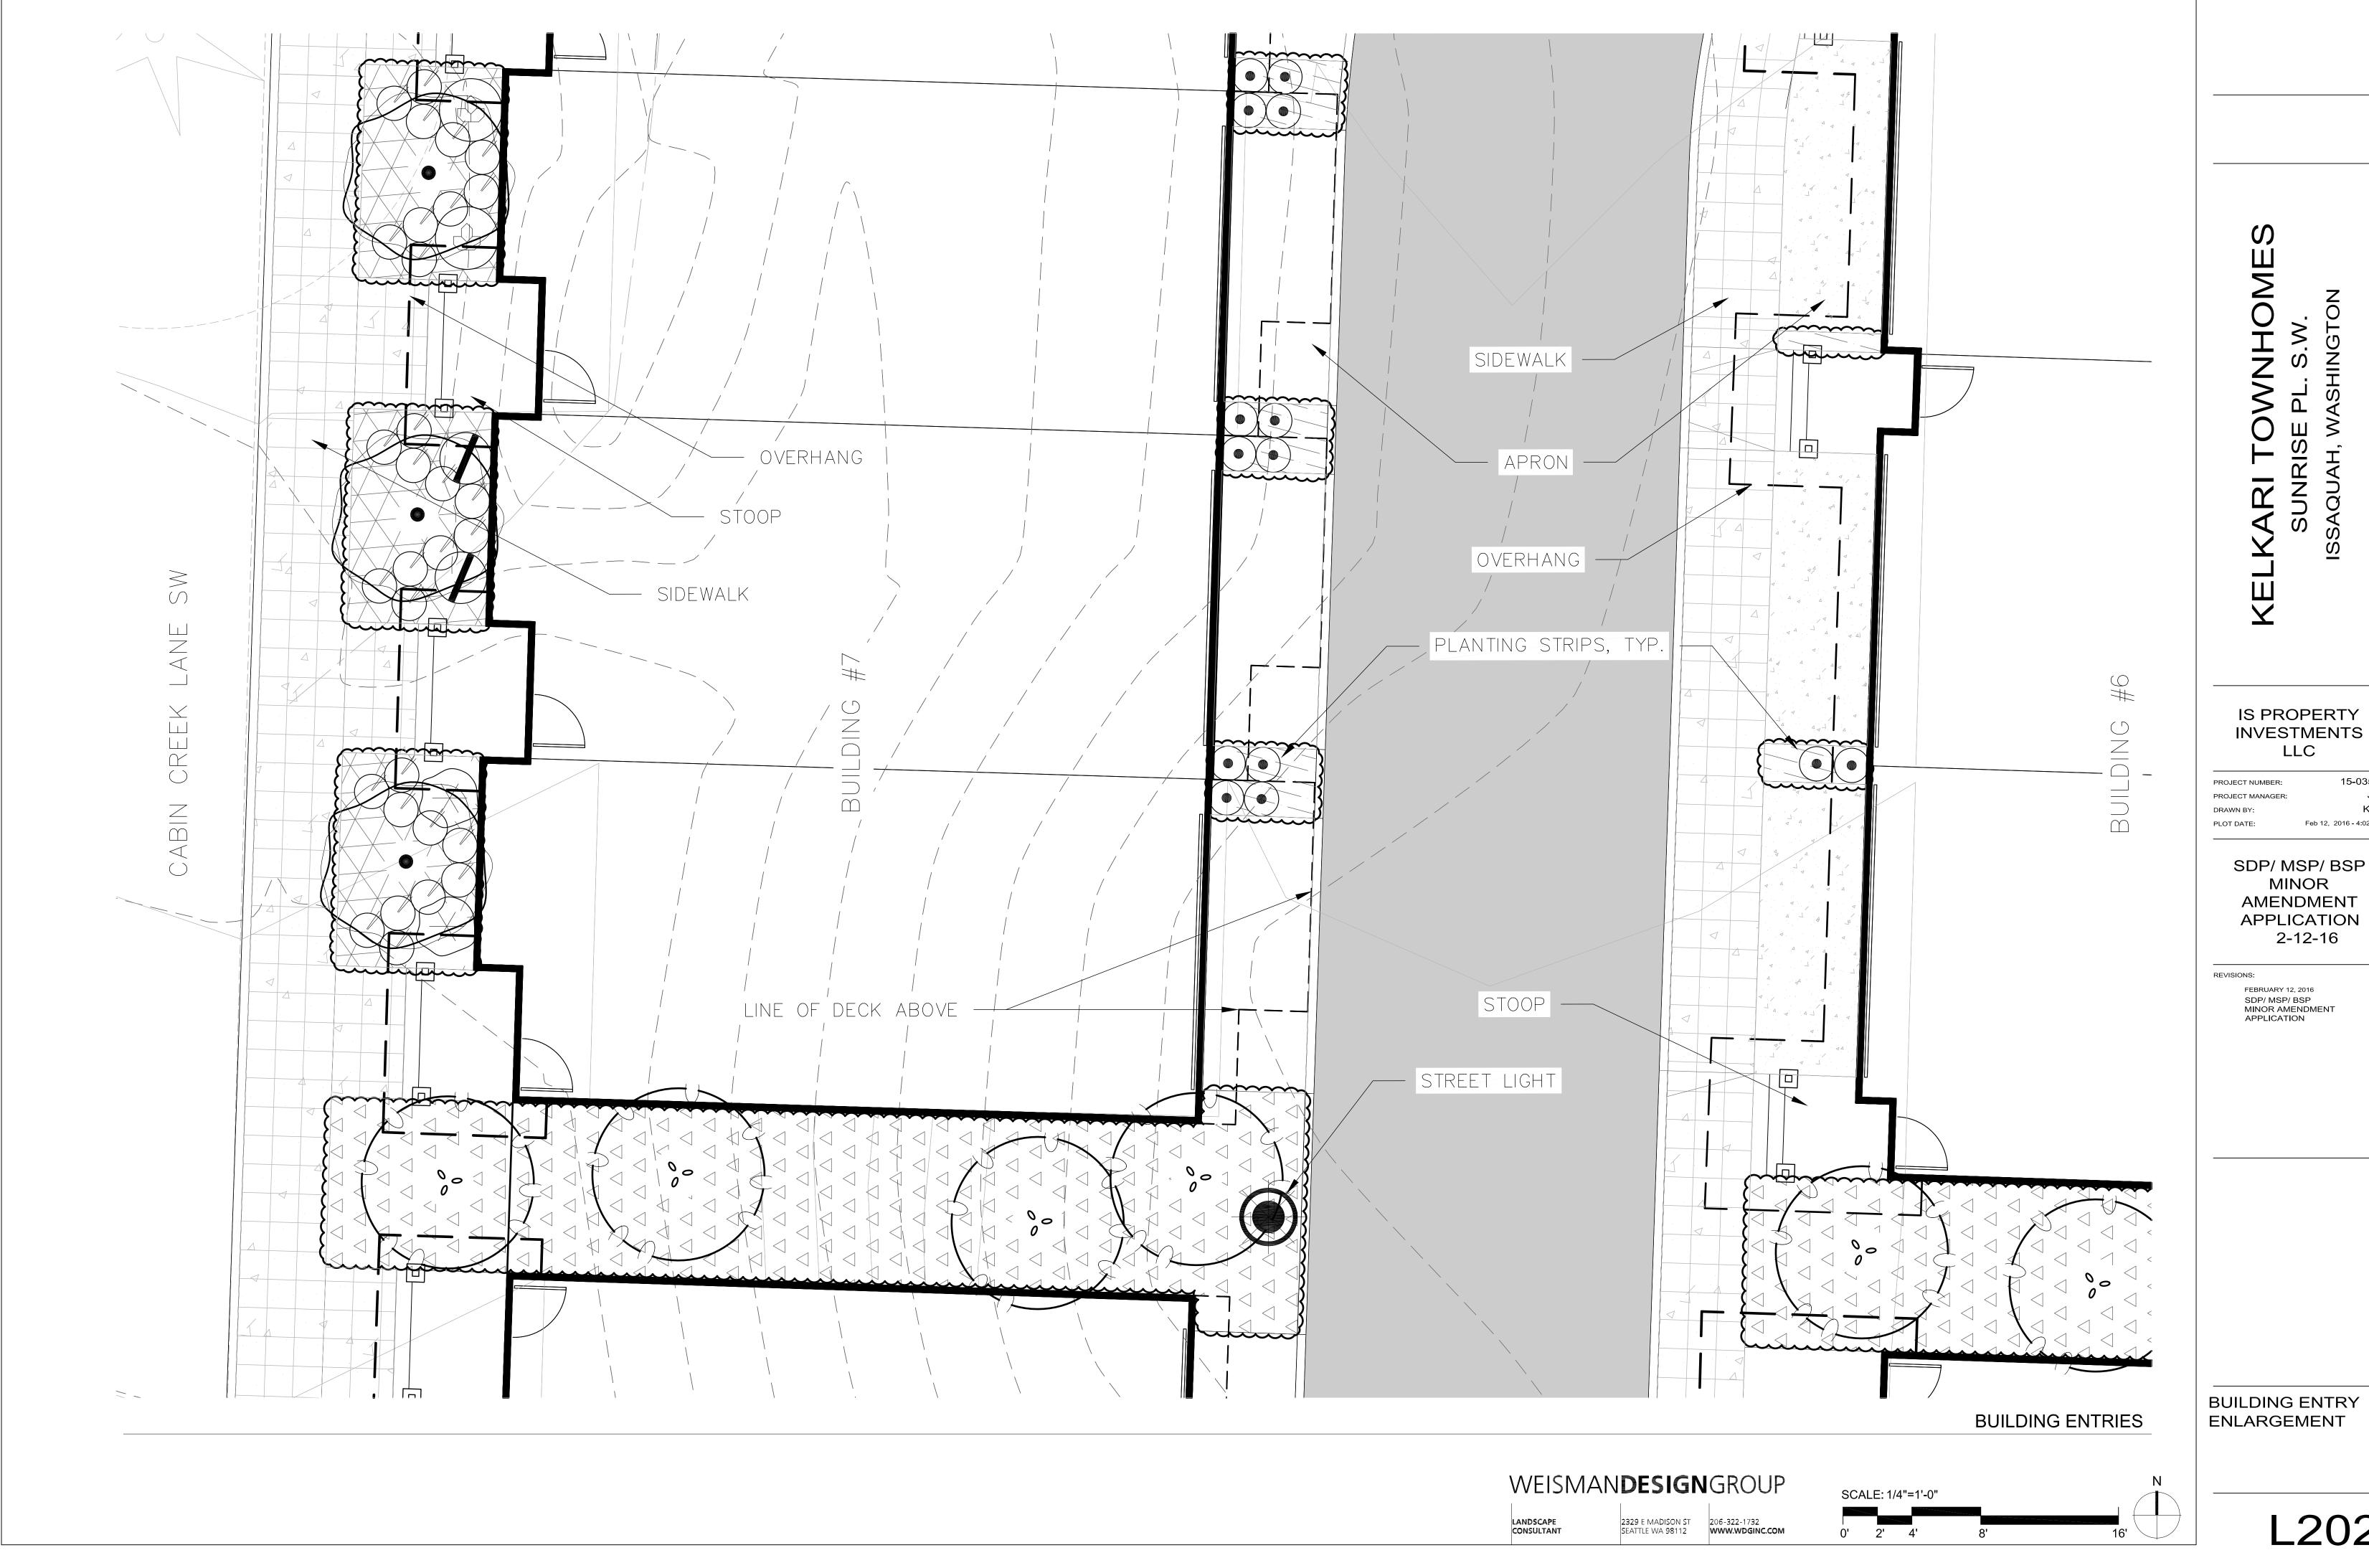


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**BUILDING ENTRY** 



LANDSCAPE STRUCTURES NATURAL PLAY STRUCTURES



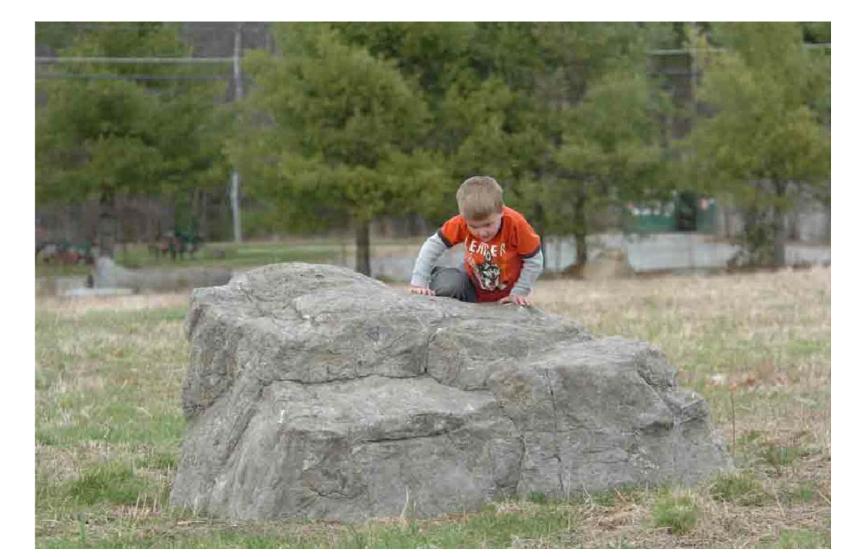

CHUNKY WOOD TRELLIS

CLIMBING BOULDER WALL

CLIMBING BOULDERS (nothing larger than this)










LANDFORMS BENCH

LANDFORMS PICNIC TABLE

BIKE RACK

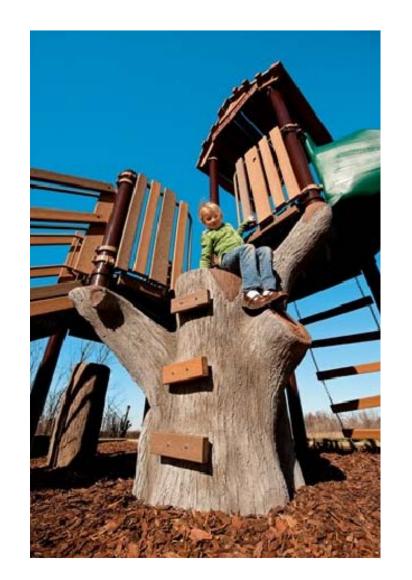



**ENTRY MONUMENTS** 

WEISMAN**DESIGN**GROUP

IS PROPERTY **INVESTMENTS** 

PROJECT NUMBER: PROJECT MANAGER: Feb 12, 2016 - 11:44am

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MINOR **AMENDMENT** APPLICATION 2-12-16

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%" CRUSHED ROCK, SEE PLANS FOR LOCATIONS. MIN. 6" DEPTH, COMPACT TO 95% LEVEL AREA - SEE PLAN FOR WIDTH SLOPE
AT 1 % EXISTING SUBGRADE, COMPACT TO 95% BENEATH PATH

NOTE: 1. PRE-STAKE PATH IN FIELD FOR APPROVAL BY OWNER'S REPRESENTATIVE. 2. CLEAR AND GRUB TO 6" DEPTH.

B GRAVEL PATH

PROVIDE SMOOTH EVEN TRANSITION INTO EXISTING GRADES

DRIPLINE -TYPICAL TREE PROTECTION AREA

TREE PROTECTION

# NOTES:

1. A 6-FOOT HIGH TEMPORARY CHAIN LINK FENCE MUST BE PLACED AT THE DRIPLINE OF TREES FOUR BUSINESS DAYS PRIOR TO THE COMMENCEMENT OF DEMO & EARTHWORK. NOTIFY THE CLEARING AND GRADING INSPECTOR TO GET BOTH THE INSPECTION AND WRITTEN APPROVAL OF FLAGGED TREES AND TEMPORARY PROTECTION FENCING AROUND TREES TO BE SAVED PER THE APPROVED CLEARING AND GRADING PLAN.

2. SIGNAGE NOTING THAT TREES WITHIN THE FENCING ARE TO BE SAVED, AND THAT NO MATERIAL STORAGE IS ALLOWED WITHIN THE FENCING SHALL BE PLACED ON THE FENCE IN A CONSPICUOUS LOCATION.

3. NO STOCKPILING OF MATERIAL AND NO VEHICULAR TRAFFIC ARE ALLOWED WITHIN THE LIMITS OF THE TEMPORARY FENCING. ONLY LIMITED INTRUSION INTO TREE DRIPZONES WILL BE ALLOWED AS SHOWN ON THE APPROVED PLANS. FILLING, EXCAVATING, AND CLEARING MUST BE ACCOMPLISHED BY HAND METHODS ONLY.

4. ROOTS OF TREES TO BE SAVED WHICH ARE DAMAGED DURING CONSTRUCTION WILL BE TREATED IN THE FOLLOWING WAY:

FOR DAMAGED ROOTS OVER 1" IN DIAMETER, MAKE A CLEAN, STRAIGHT CUT TO REMOVE THE DAMAGED PORTION OF THE ROOT. ALL EXPOSED ROOTS WILL BE TEMPORARILY COVERED WITH DAMP BURLAP OR WOOD SHAVING TO PREVENT DRYING AND COVERED WITH EARTH AS SOON AS POSSIBLE.

5. SEE PLAN FOR LOCATION OF EXISTING TREES TO RECEIVE TEMPORARY FENCING.

WEISMAN**DESIGN**GROUP

2329 E MADISON ST 206-322-1732 SEATTLE WA 98112 **WWW.WDGINC.COM** LANDSCAPE CONSULTANT

SCALE: 1"=30'-0" 0' 15' 30'

LANDSCAPE DETAILS



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# SUNRISE PL. S.W.

# IS PROPERTY INVESTMENTS LLC

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PROJECT MANAGER: JG
DRAWN BY: BD
PLOT DATE: Feb 12, 2016 - 11:01am

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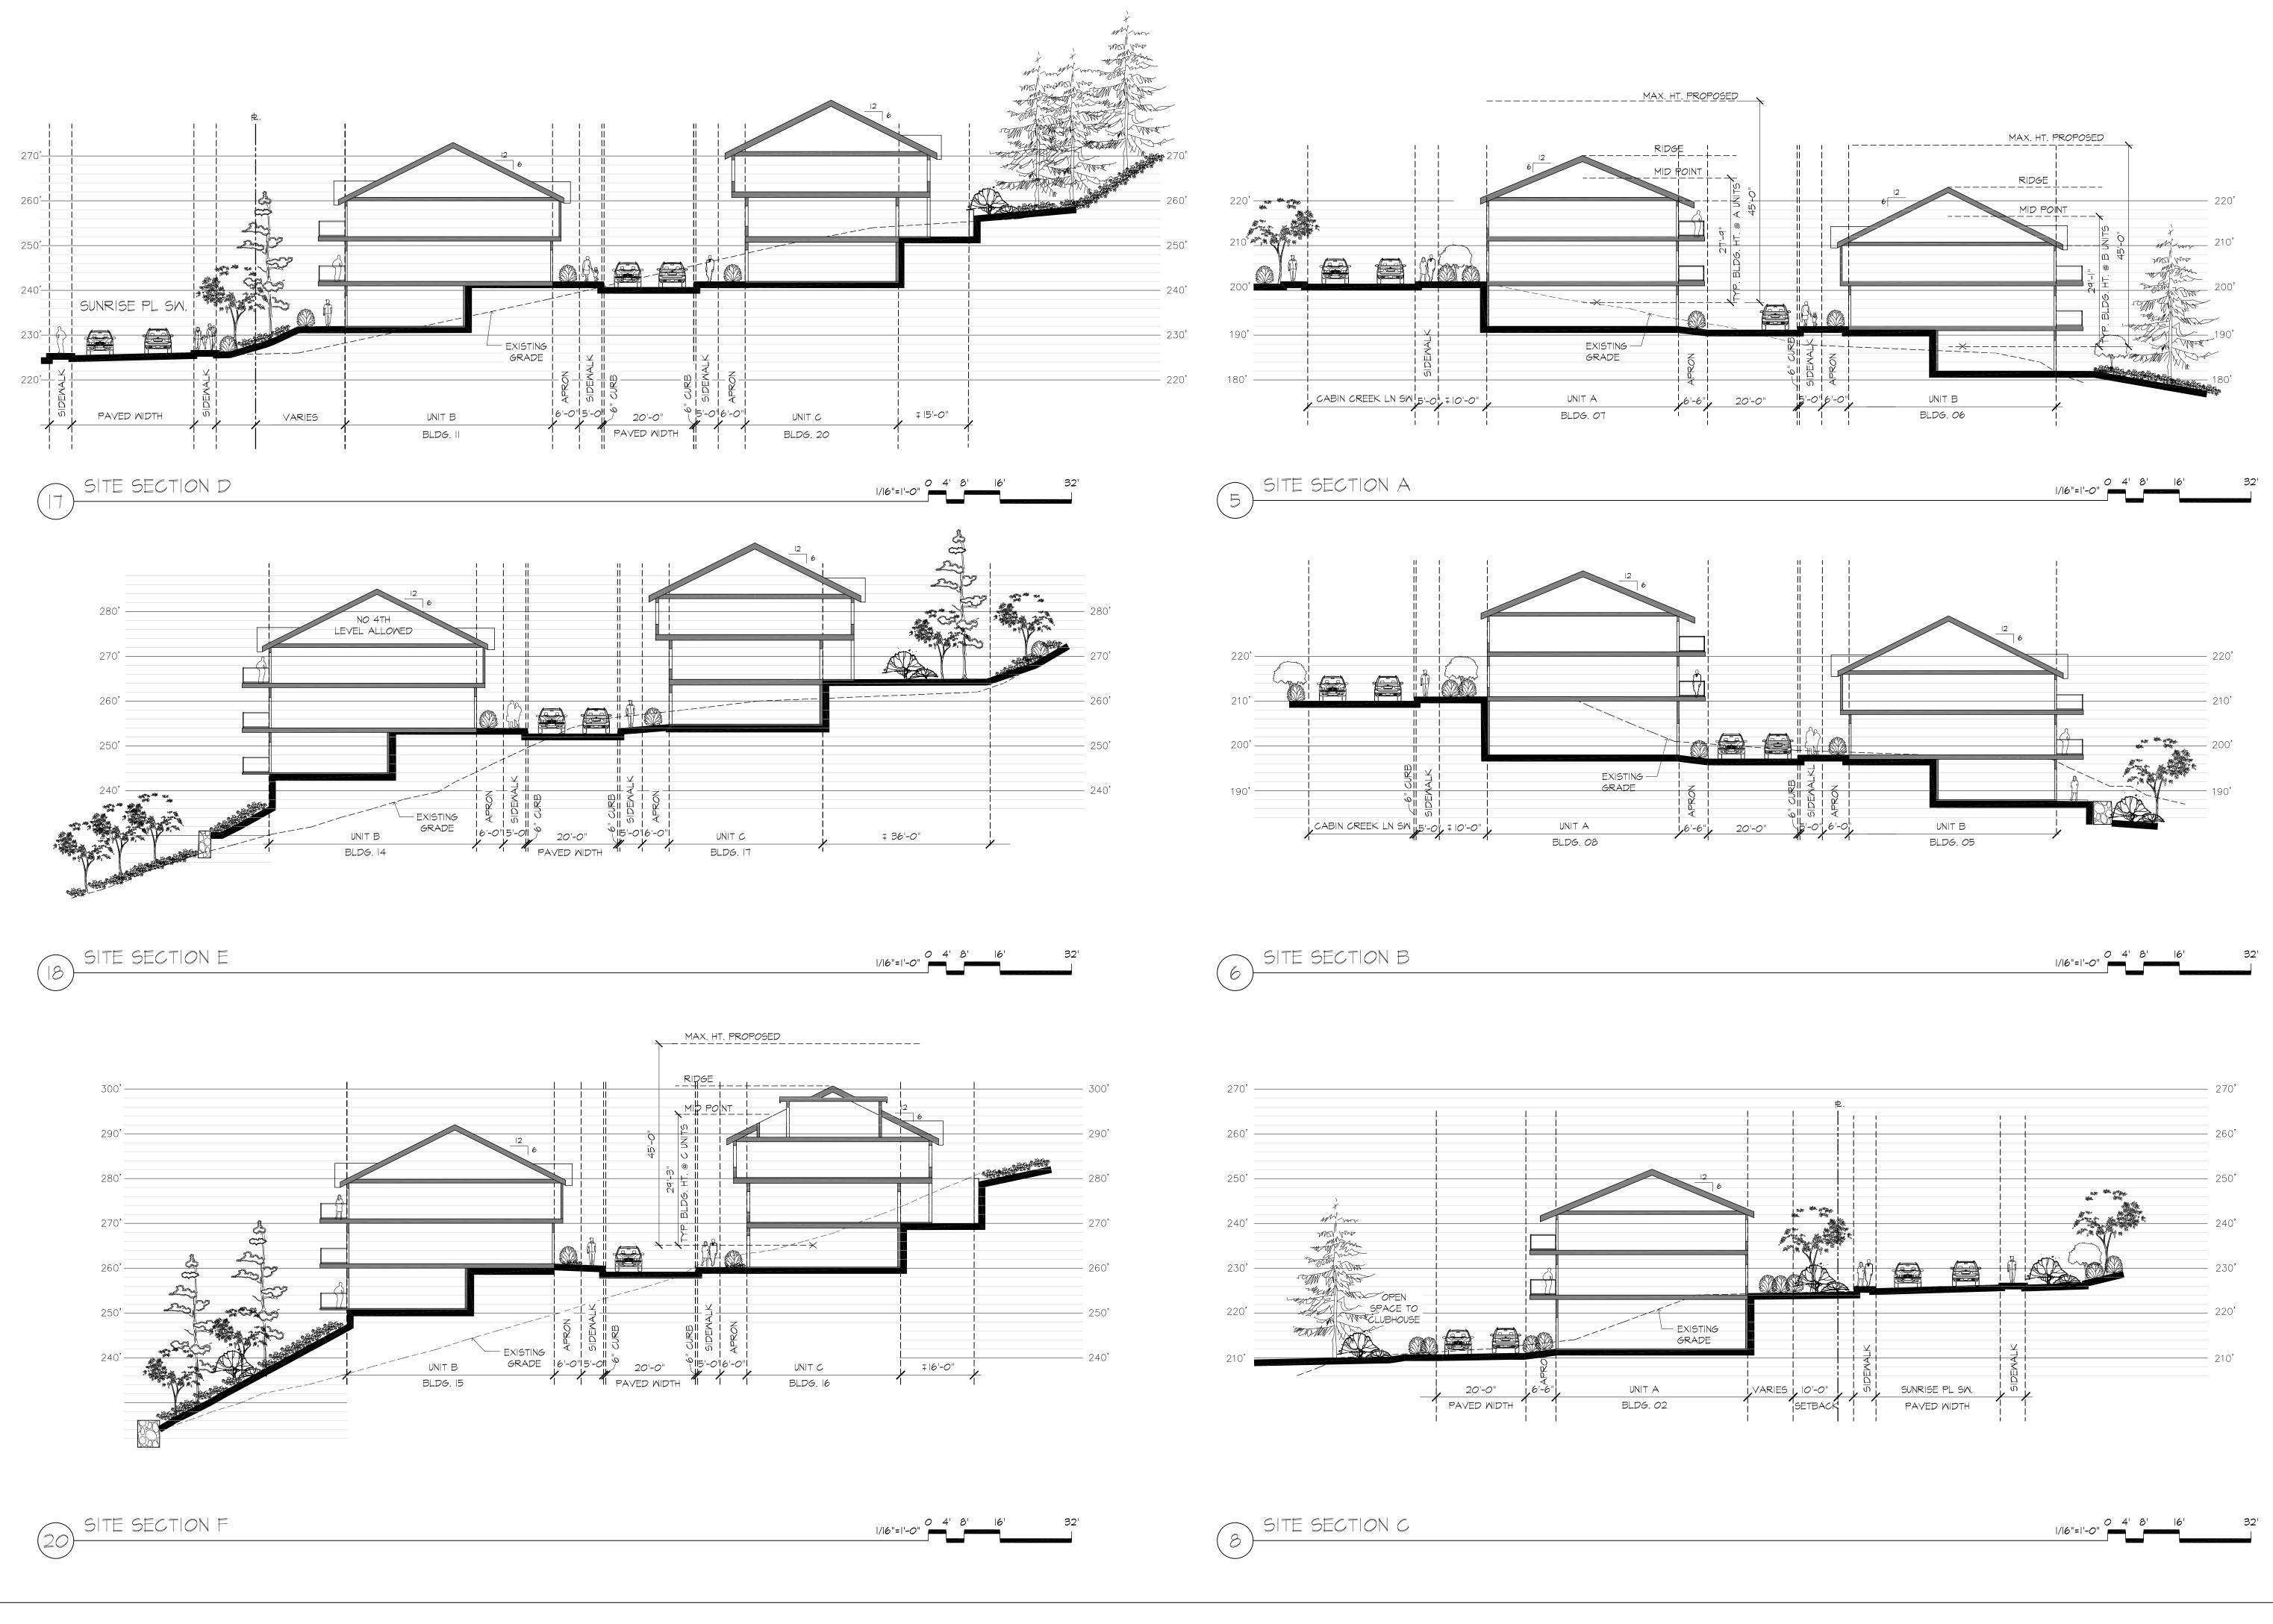
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SITE PLAN PHASE II & III

A02



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SUNRISE PL. S.W.

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SITE SECTIONS PHASE II & III

**A03** 



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PROJECT MANAGER:	JG
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2-12-16

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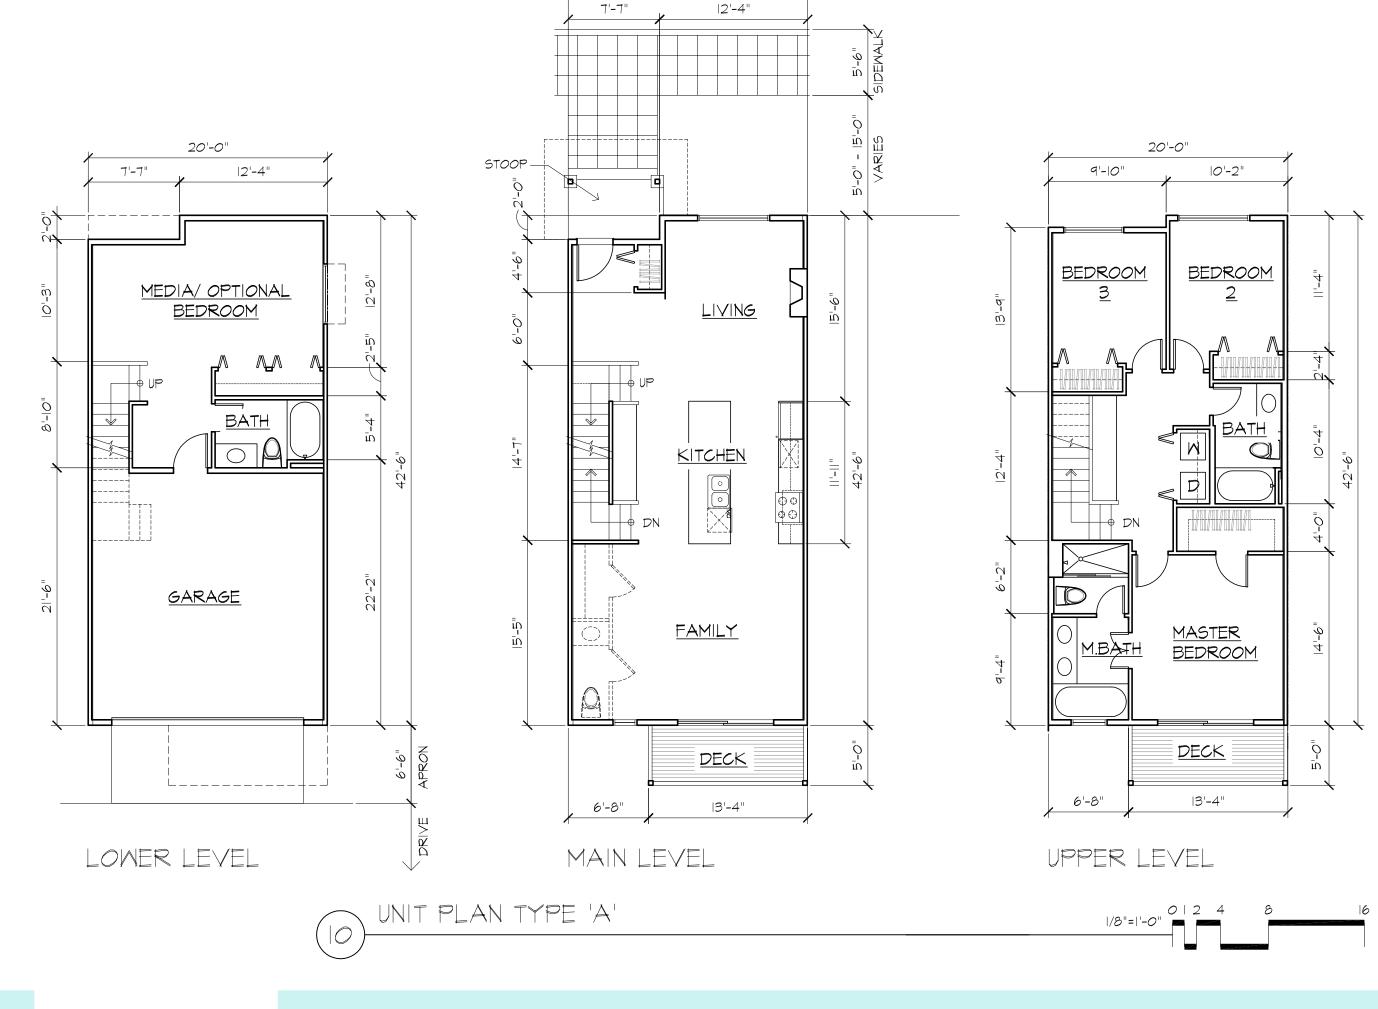
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FLOOR PLANS

UNIT A





1 - BALCONY

ROOF LEVEL

UPPER LEVEL

MAIN LEVEL


LOMER LEVEL

EXTERIOR ELEVATION - SIDE

EXTERIOR ELEVATION - REAR



EXTERIOR ELEVATION - FRONT

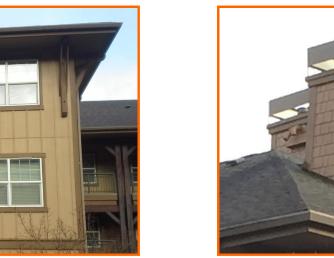

4 - CHIMNEY



5 - GABLE ROOF



6 - COLUMN **BASE** 



UNIT MATRIX

MAIN LEVEL

TOTAL:

UPPER LEVEL

LOWER LEVEL

374 SF

831 SF

890 SF

2,094 SF


7 - TRIM AND **TRANSITION** OF MATERIALS



3 - EXTERIOR **BRACKET** 

2 - WATER TABLE



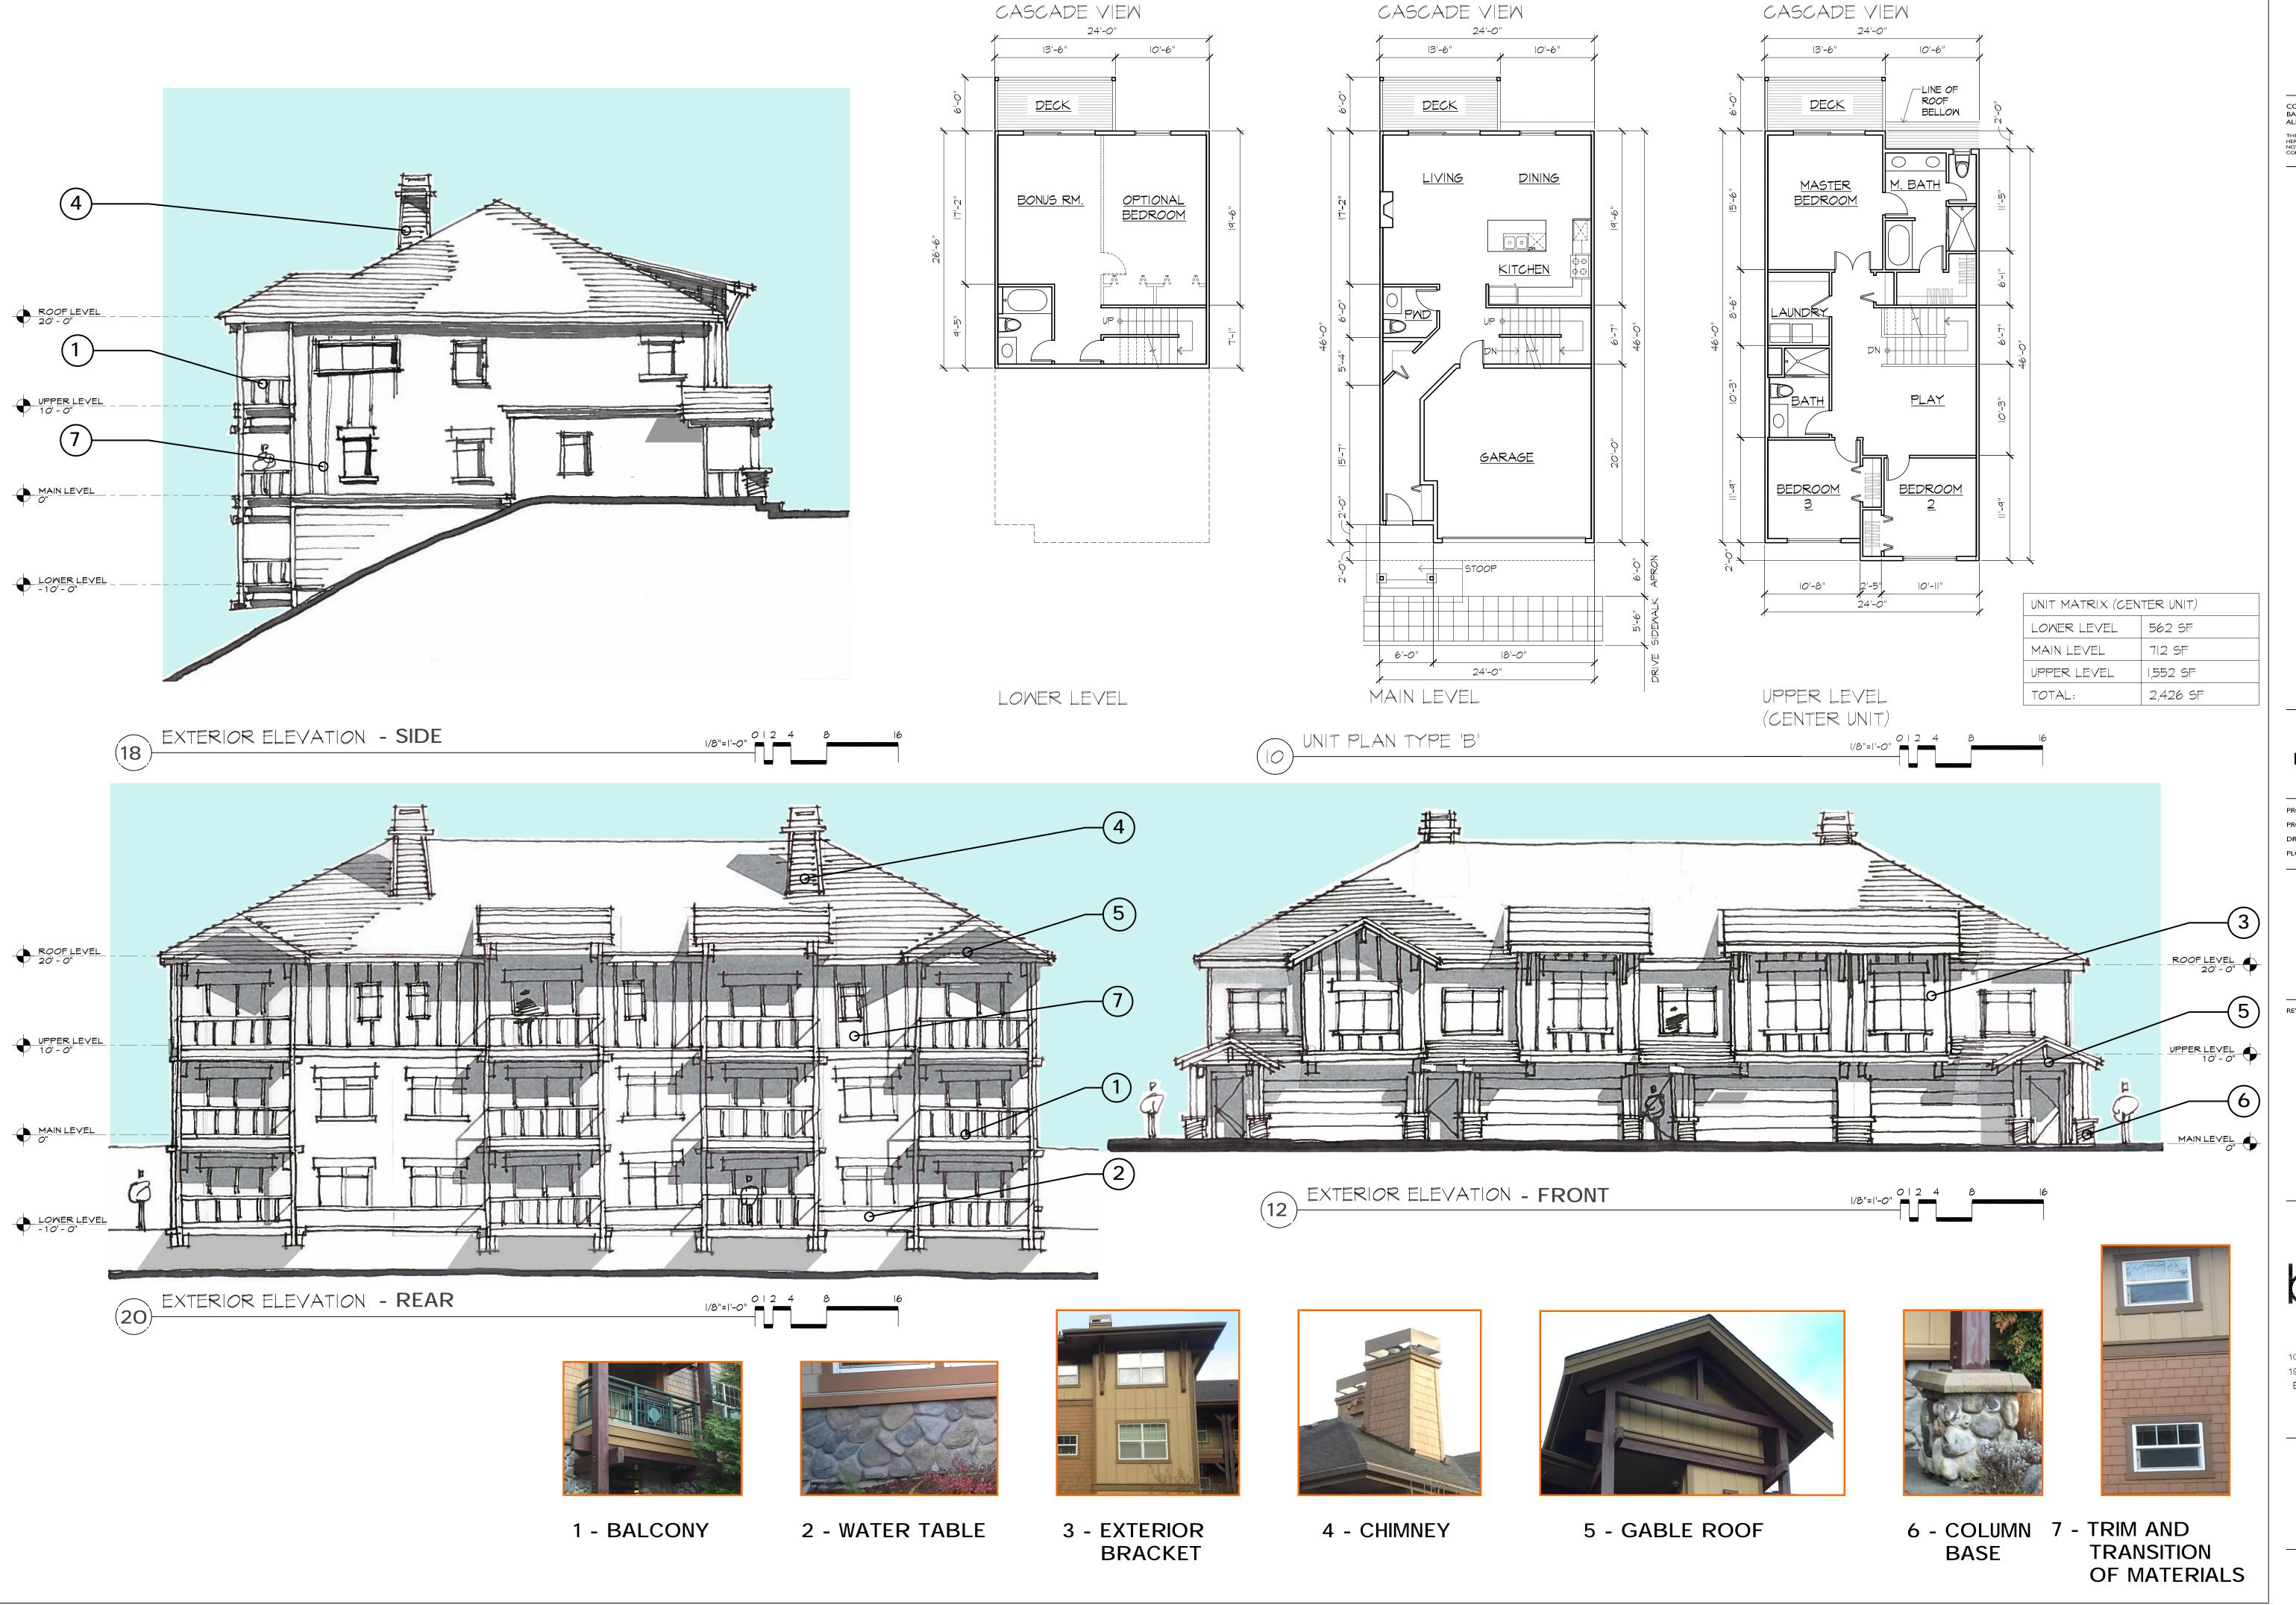

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KARI TOWNHOMES SUNRISE PL. S.W.

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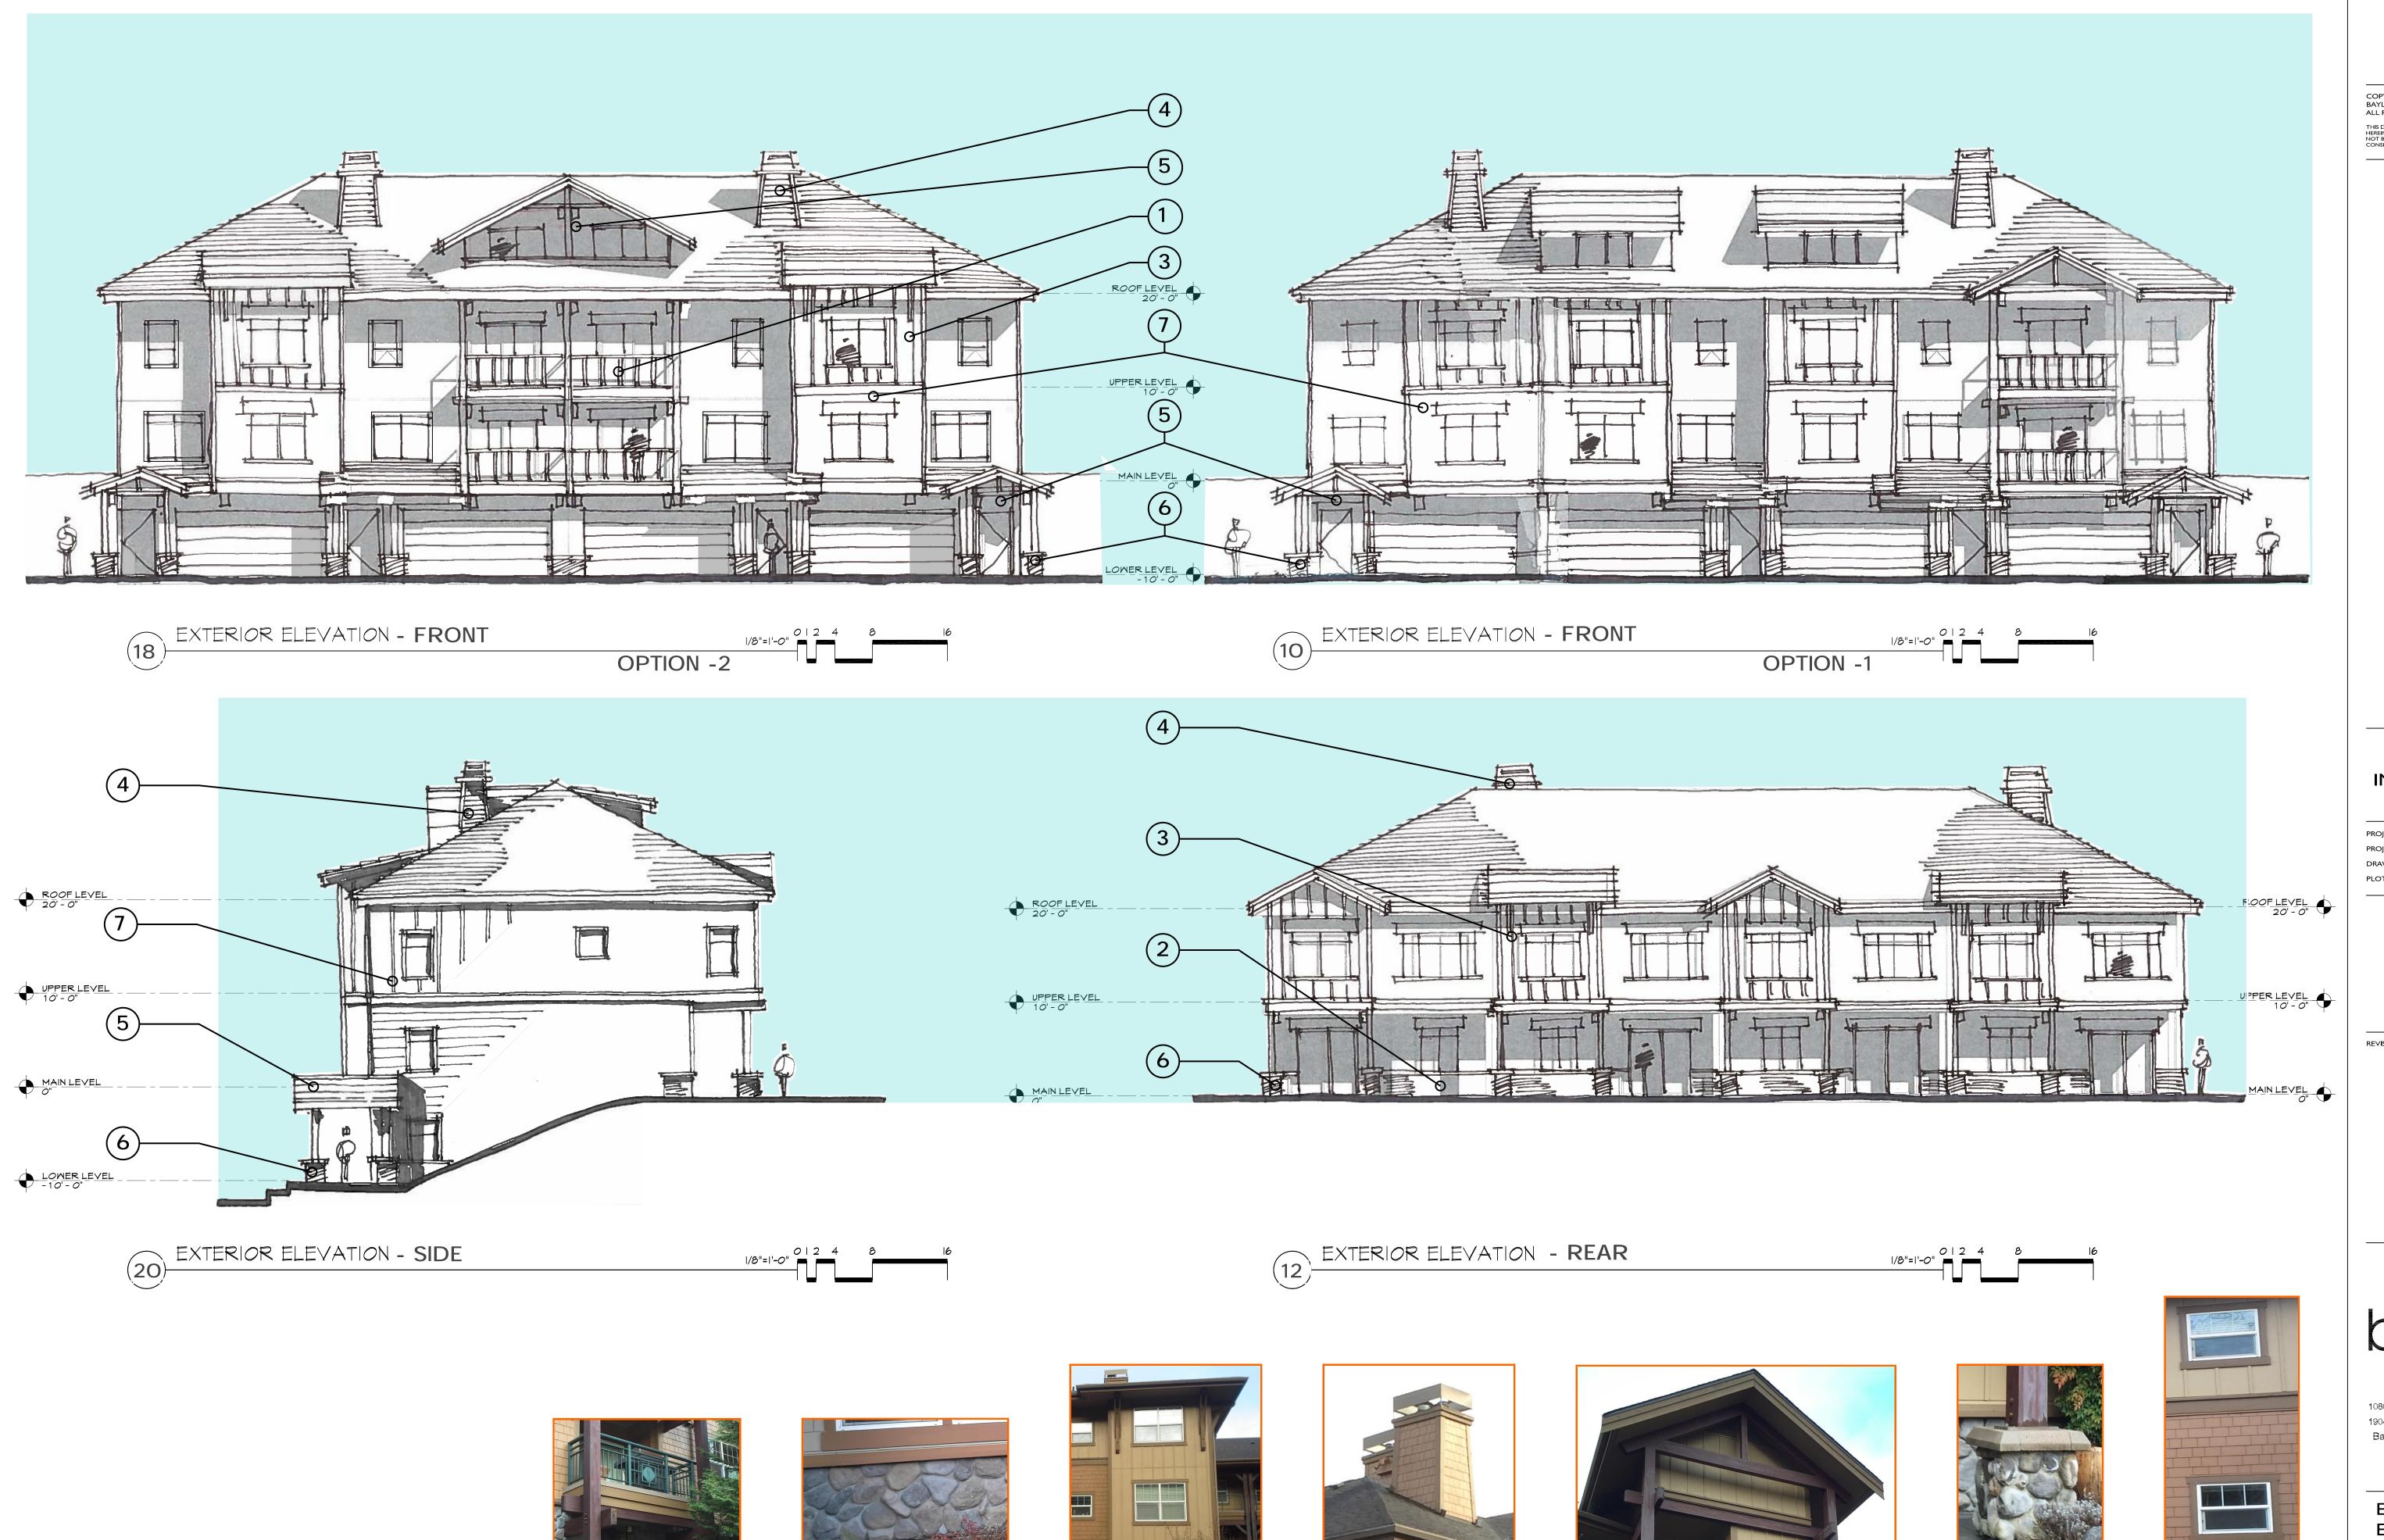
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FLOOR PLANS

UNIT B

**A05** 



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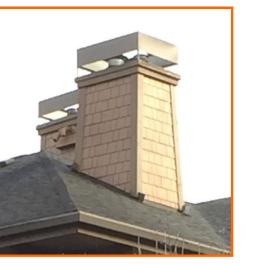
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**EXTERIOR ELEVATIONS** UNIT C

3 - EXTERIOR **BRACKET** 

2 - WATER TABLE

1 - BALCONY



4 - CHIMNEY





5 - GABLE ROOF



6 - COLUMN 7 - TRIM AND **BASE** 

**TRANSITION** OF MATERIALS

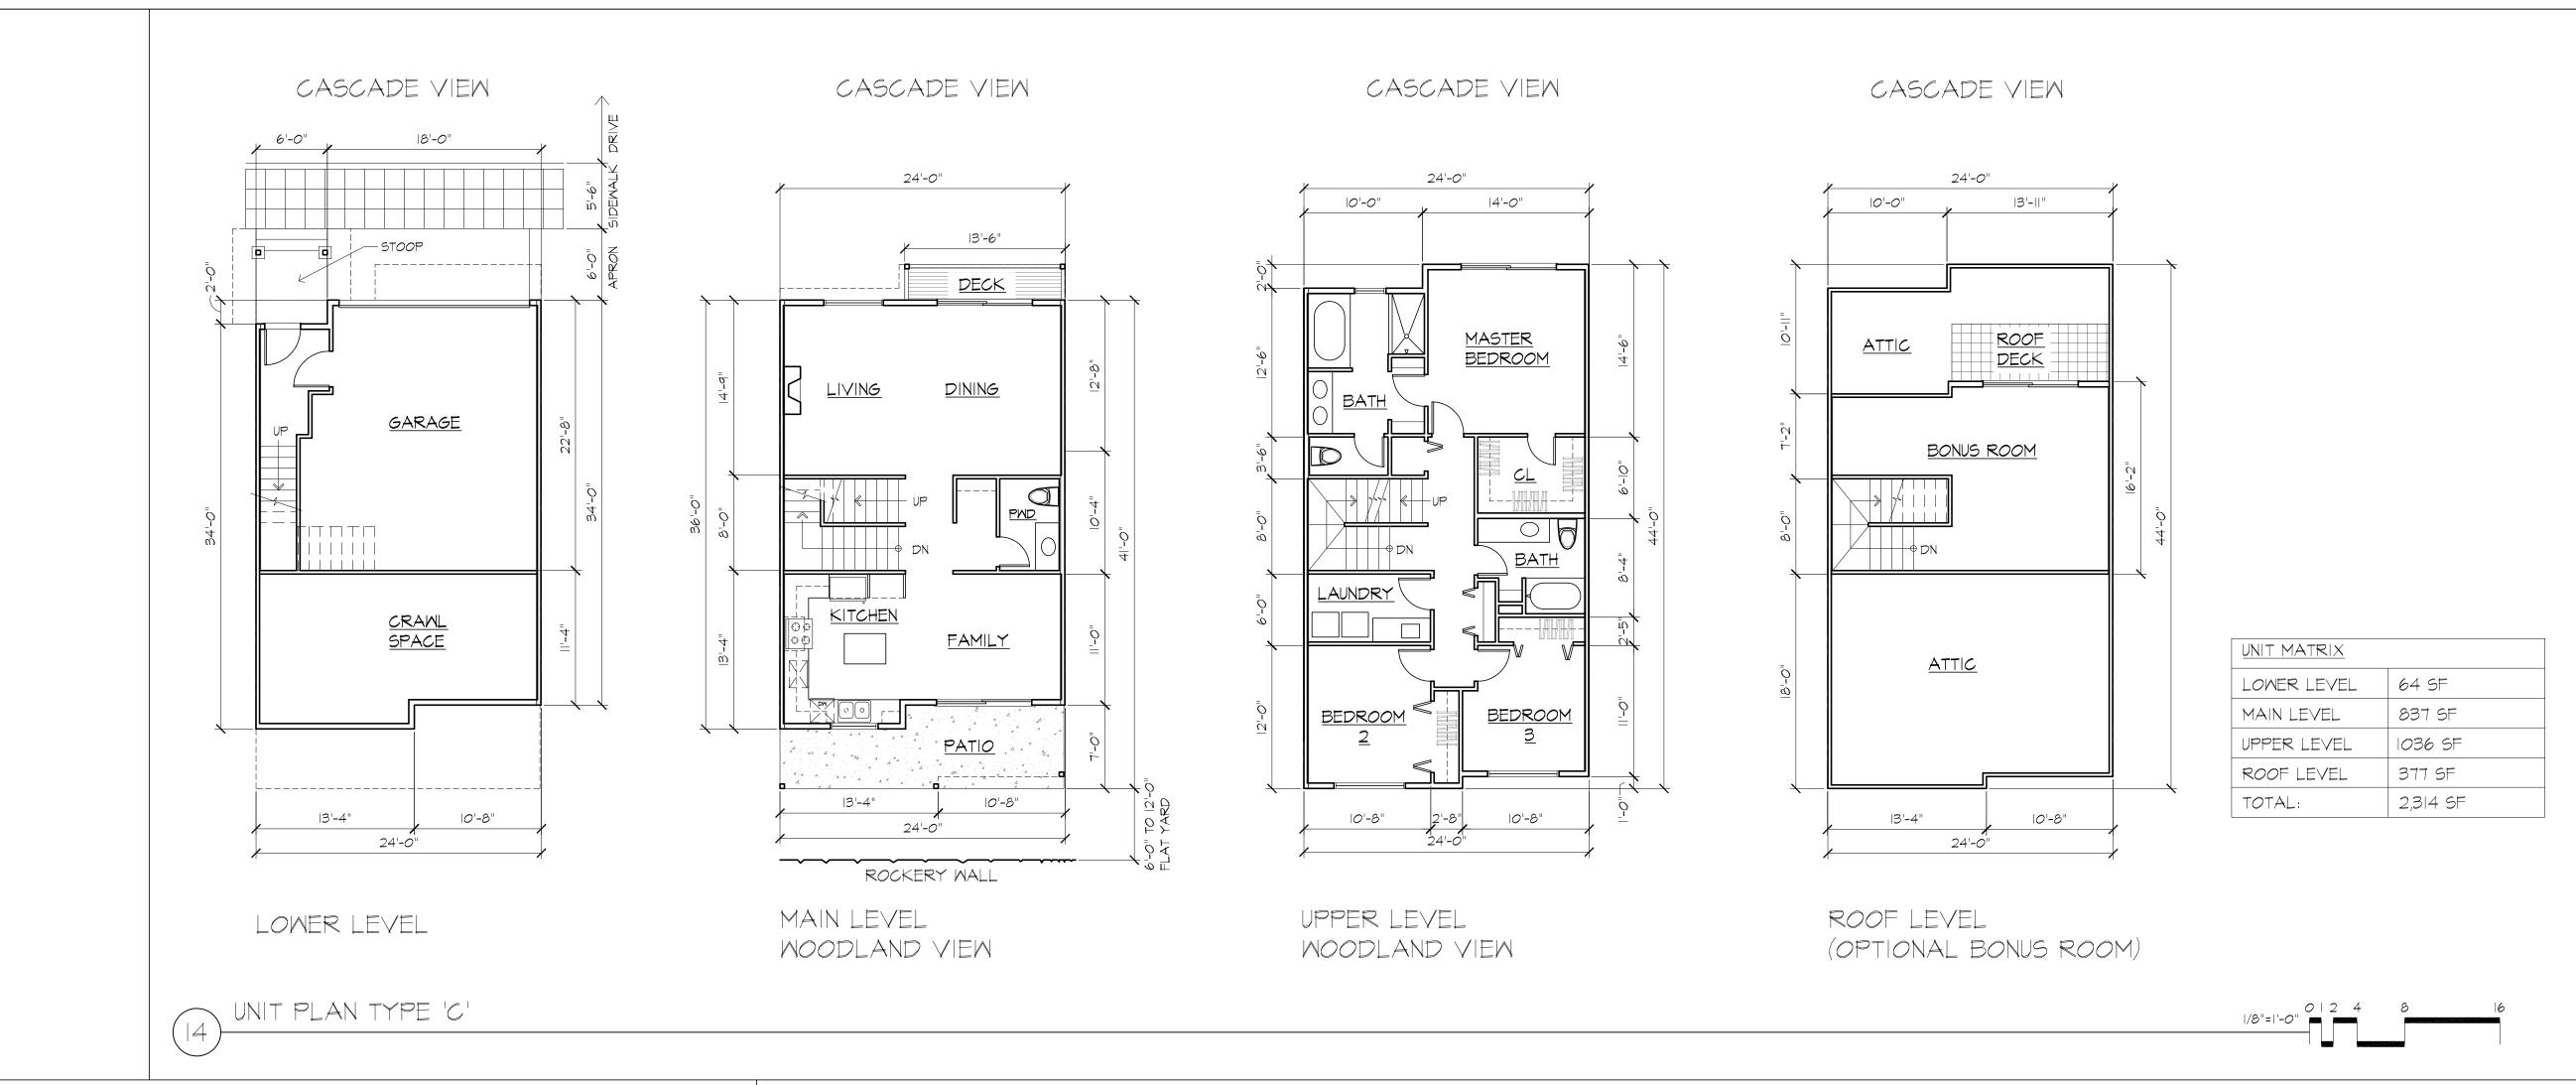

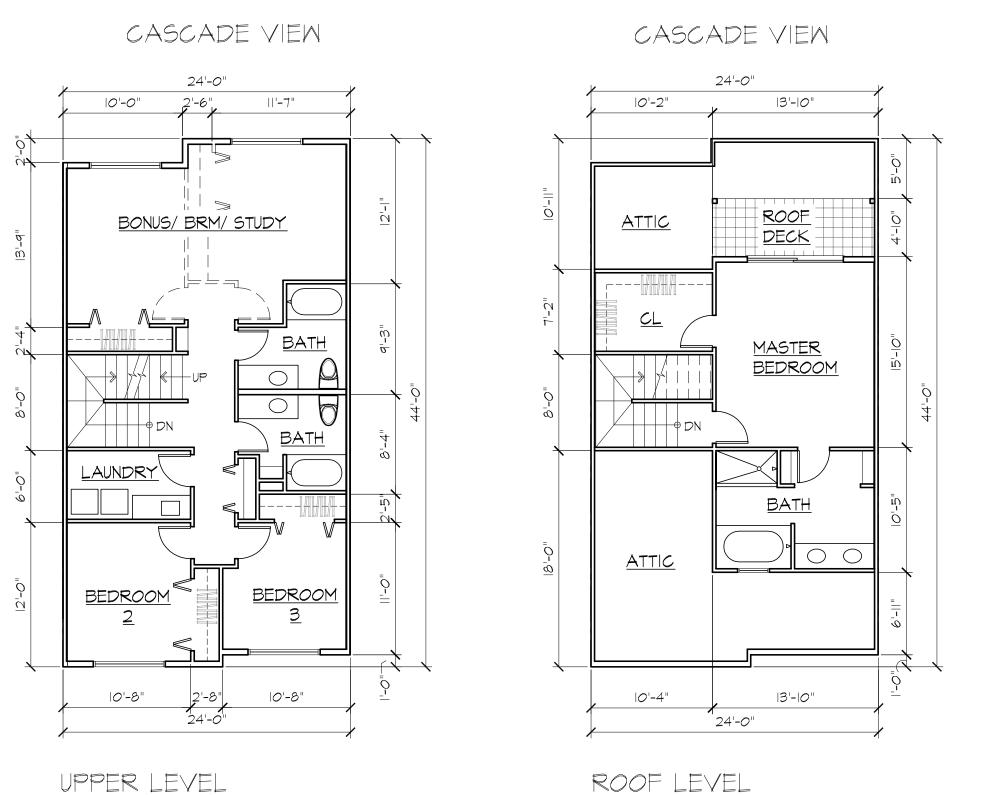

UNIT MATRIX	
LOWER LEVEL	64 SF
MAIN LEVEL	837 SF
UPPER LEVEL	1036 SF
ROOF LEVEL	503 SF
TOTAL:	2,440 SF

ROOF LEVEL (OPTIONAL MASTER BEDROOM)

ROOF LEVEL OPTION - UNIT PLAN TYPE 'C' (12) BUILDINGS 16, 17, 18 \$ 19

WOODLAND VIEW

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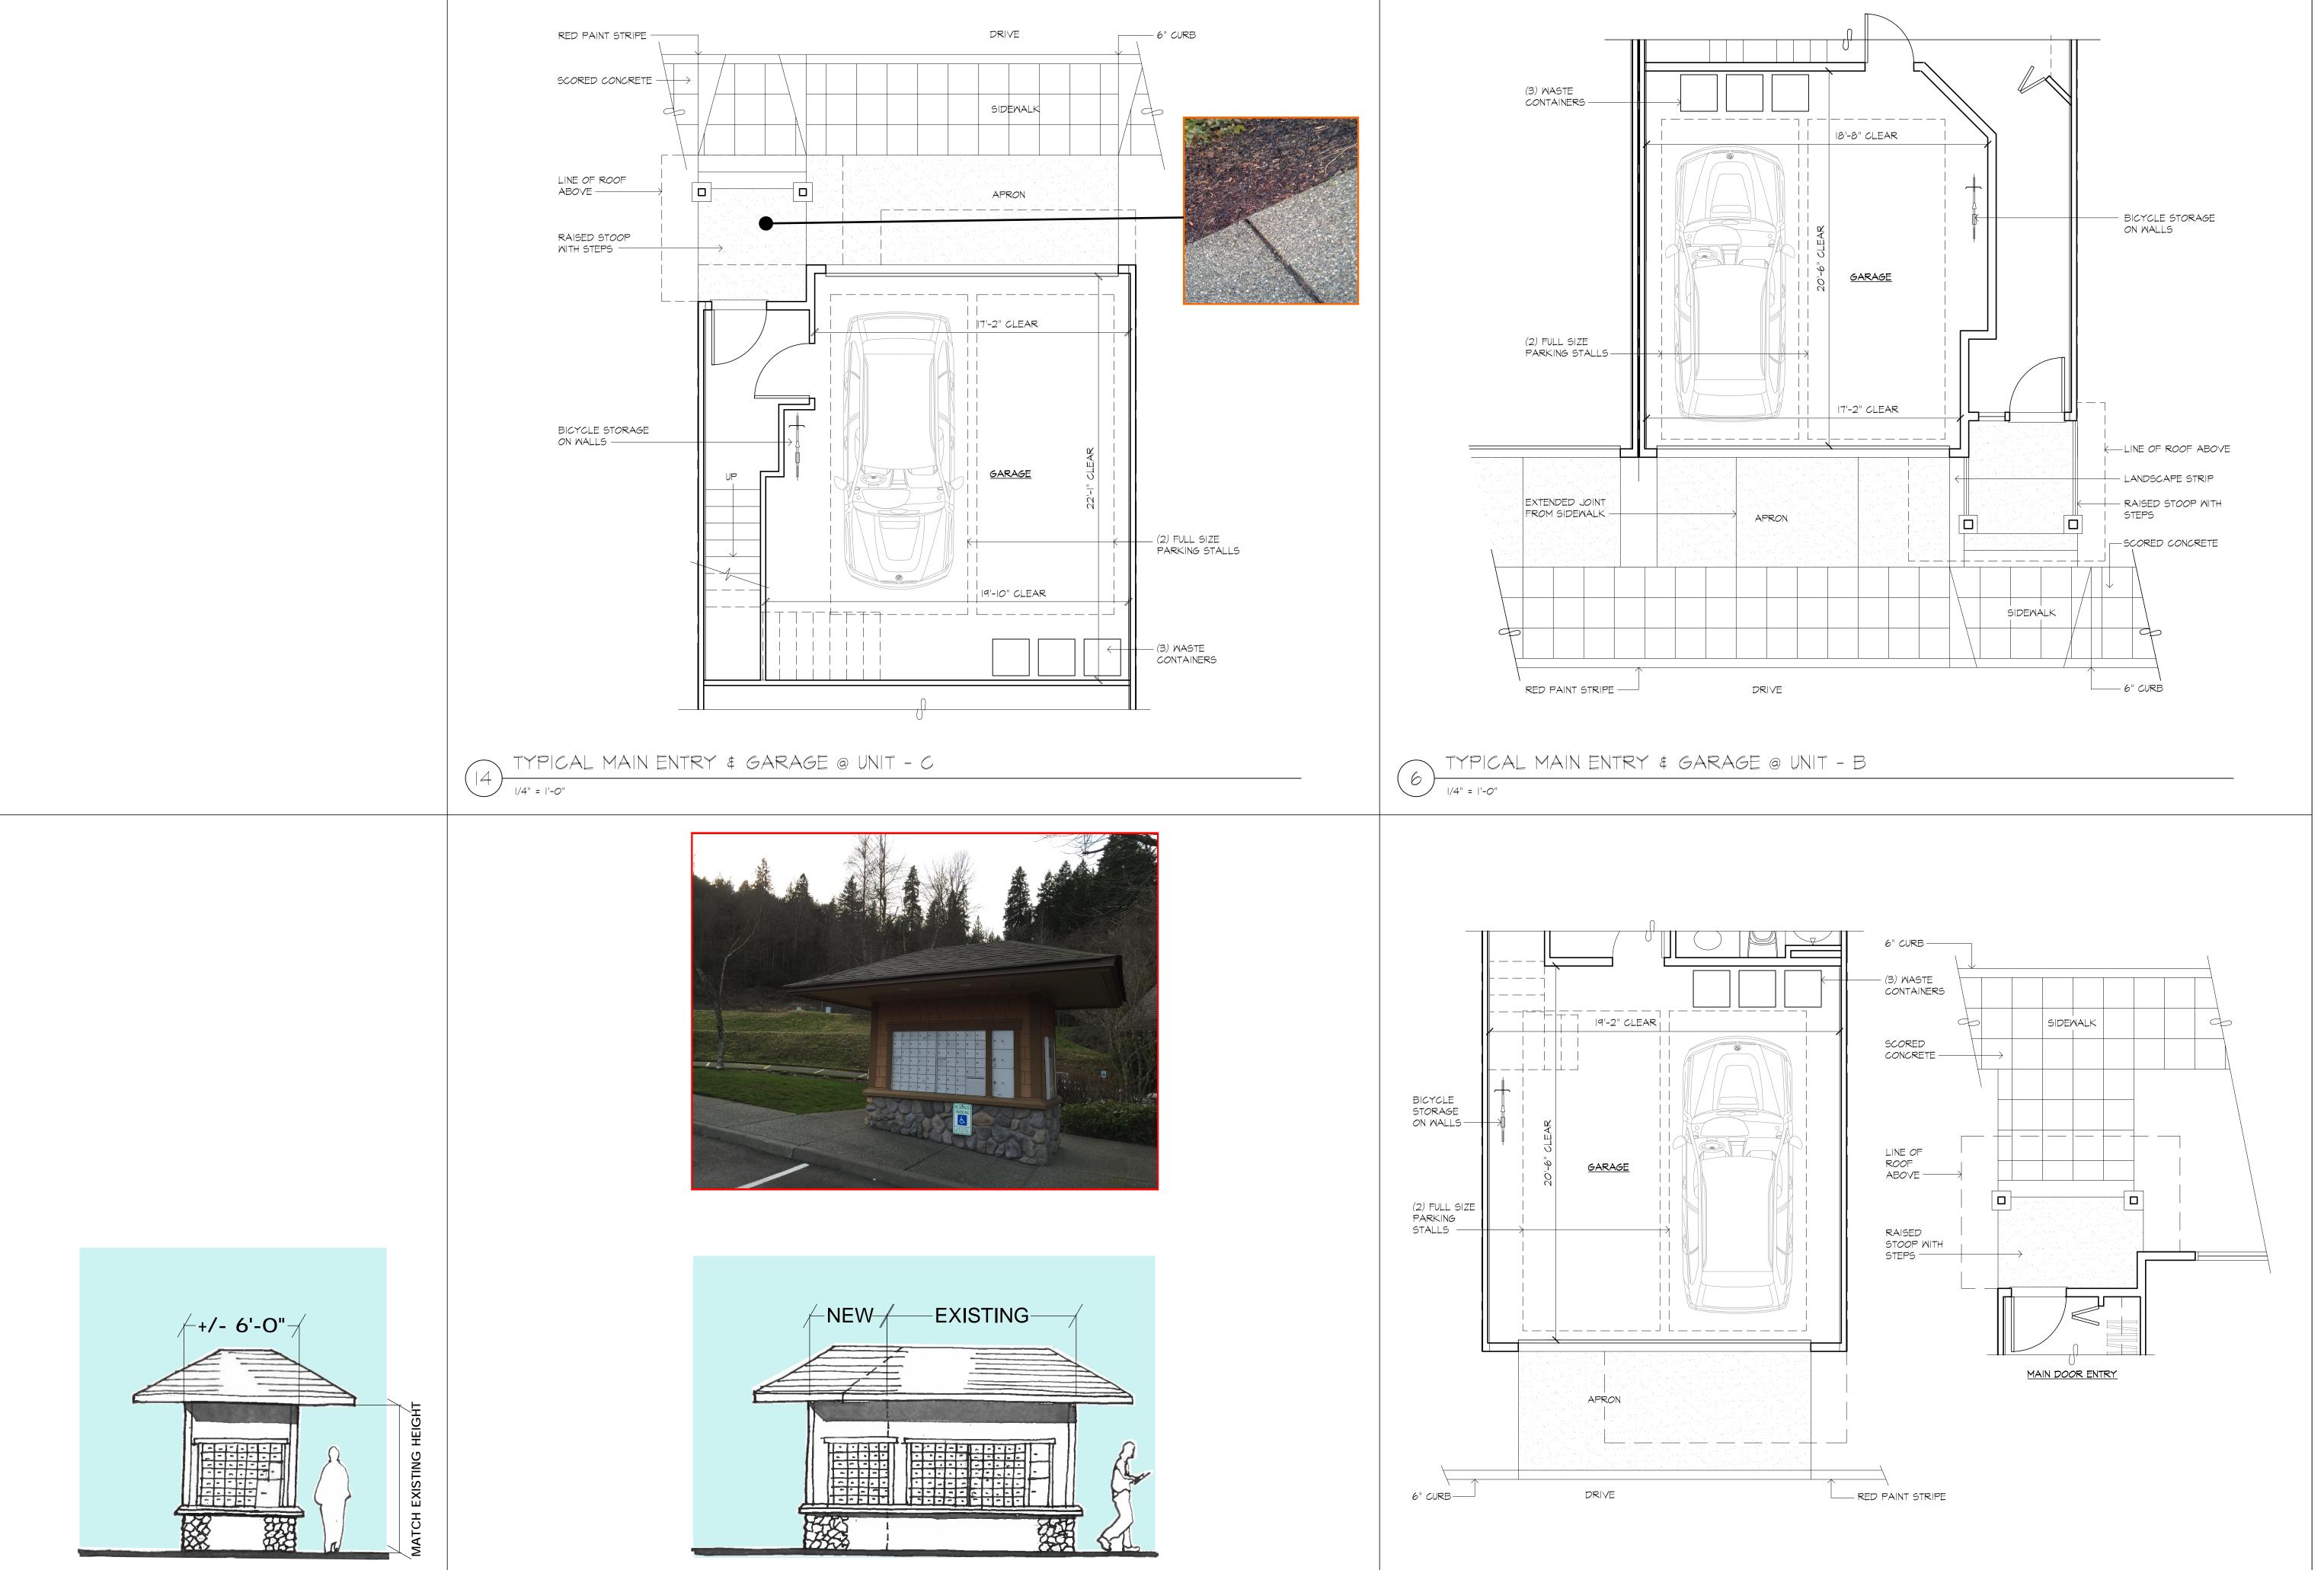
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FLOOR PLANS UNIT C



TYPICAL MAIN ENTRY & GARAGE @ UNIT - A

ADDITION TO EXISTING MAIL KIOSK AT PHASE II

NEW MAIL KIOSK AT PHASE III

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PROJECT MANAGER: JG
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MAIL KIOSK & ENLARGED PLANS

**80A** 

Golden Meadow

SW 2165-20

Shingle Siding

Delightful Gold SW 2158-30

Golden Tan

SW 2152-40

Toasted Chestnut

SW 2174-10

Plymouth Brown

SW HC -73

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SUNRISE PL. S.W.

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PROJECT MANAGER: JG

DRAWN BY: BD

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44750141

MATERIAL BOARD

Roof

Stone

Lap Siding

Board & Batten Siding

A09